ADDENDUM

DESIGN

WHITE

A DESIGN

ROBERT

No.

AR00900°

STATE

ARCHITECTURE · INTERIOR DESIGN

ADDENDUM NO: 1

BID PACKAGE NO: All

PROJECT: BCSC Johnson Early Education Center Renovations Phase 2

PROJECT NO: 2024004 .1 BY: Jennie Gaw DATE: 12/04/2024

This Addendum is issued in accordance with the provisions of "The General Conditions of the Contract for Construction," Article 1, "Contract Documents" and becomes a part of the Contract Documents as provided therein. This Addendum includes:

Addendum Pages: ADD 1 - ADD 3

Attachments: 10 26 23 Decorative Wall Protection Panels, S201, A101, A110, AD200, A210, A401, A501,

A502, A601, A701, A900

PART 1 - BIDDING AND CONTRACT REQUIREMENTS

1.01 NOT USED

PART 2 - SPECIFICATIONS

- 2.01 <u>10 26 23 – Decorative Wall Protection Panels</u>
 - A. Removed paragraph 2.03 CUSTOM IMAGE PANEL
 - 1. "Custom Image Wall Panel System: Basis of design system as indicated below.
 - 1. Manufacturer: Construction Specialties
 - 2. Type: Acrovyn by Design
 - 3. Size: 2' x 2'
 - 4. Finish: Custom Images to be selected by Architect.
 - 5. Material: Engineered PVC FREE rigid sheet to be Acrovyn by Design: High-definition graphic file digitally printed on reverse side of clear sheet and sealed with protective backer. Either to be customer provided artwork with copyright clearance file, or one of Acrovyn by Design Pattern Collections, Specify color-matched caulk, clear caulk, Acrovyn trims or aluminum trims as needed for joints/transitions. Specific files used on the project are noted below. See floor plans and finish schedule for coordinating locations."

PART 3 - DRAWINGS

STRUCTURAL

S201 - ROOF FRAMING PLAN 3.01

A. Reissue this sheet in its entirety.

ARCHITECTURAL

3.02 <u>A101 – OVERALL FLOOR PLANS</u>

- A. Structural grids removed.
- B. North arrows added to plans.

3.03 A110 – LIFE SAFETY PLAN

- A. Total door width required changed to 830 inches.
- B. Changed: "3'-0" DOOR (33.2" CLEAR WIDTH) AT 0.2" PER OCC. = 166 OCC."
- C. Changed: "PR. 3'-0" DOOR (66.4" CLEAR WIDTH) AT 0.2" PER OCC. = 332 OCC."
- D. Changed: "PR. 4'-0" DOOR (45.2" CLEAR WIDTH) AT 0.2" PER OCC. = 226 OCC."

3.04 AD200 – FIRST FLOOR DEMOLITION PLAN

- A. Structural grid removed.
- B. Demolition tags added the hallways chase.
- C. Demolition notes 5 & 7 added to the corridor.

3.05 A210 - FIRST FLOOR REFLECTED CEILIGN PLAN

A. Ceiling types, room tags, and heights added.

3.06 A401 – WALL SECTIONS & PLAN DETAILS

A. Reissue page complete.

3.07 A501 – DOOR & WINDOW SCHEDULE

A. Mark Type changed from "W3" to "39" on window schedule.

3.08 A502 – HEAD, JAMB, AND SILL DETAILS

A. Head Detail – H4 changed to reflect studs.

3.09 A601 – INTERIOR ELEVATIONS

A. Added tags and dimensions to casework and equipment.

3.010 A701 – ENLARGED RESTROOM PLANS

A. Added tags and dimensions.

3.011 A900 – EQUIPEMENT PAN

Addendum ADD 2 of 3



A. Added arrows to indicate door mounted roller shades on interior and exterior doors.

PART 4 - OTHER ITEMS

4.01 NOT USED

PART 5 - QUESTION AND ANSWER

5.01 NOT USED

END OF ADDENDUM

Addendum ADD 3 of 3

DECORATIVE WALL PROTECTION PANELS

Phase 2

Bartholomew Consolidated School Corporation

SECTION 10 26 23 - DECORATIVE WALL PROTECTION PANELS

PART 1 - GENERAL

1.01 RELATED DOCUMENTS

Drawings and general provisions of the Contract, including General and Supplementary A. Conditions and Division 01 Specification Sections, apply to this Section.

1.02 SUMMARY

- A. Section includes the following wall panel/covering applications:
 - 1. Hard stop panel.
 - 2. Custom image panel.

1.03 **ACTION SUBMITTALS**

- A. Product Data: For each type of product.
 - 1. Include frame edge and trim, core material, and mounting indicated for concealed supports.
- B. Shop Drawings: For each wall panel.
 - 1. Include plans, elevations, sections, and installation and system details.
 - 2. Include details at head, base, joints, and corners; and details at ceiling, floor base, and wall intersections. Indicate frame-edge profile and core materials.
 - 3. Include details at cutouts and penetrations for other work.
- C. Samples for Verification of the following products:
 - 1. Hard stop panel: Not less than 5 by 7 inches, for each type, color, pattern, and surface finish.
 - 2. Custom image panel: (2) 24"x24" printed at full scale to show resolution, DPI, and color output.

1.04 INFORMATIONAL SUBMITTALS

- A. Coordination Drawings: Elevations and other details, drawn to scale, on which the following items are shown and coordinated with each other, using input from installers of the items involved:
 - 1. Electrical outlets, switches, and thermostats.
 - 2. Items penetrating or covered by decorative wall panels including the following:
 - Lighting fixtures. a.
 - Air outlets and inlets. b.
 - Speakers. C.
 - Alarms. d.
 - Sprinklers. e.
 - Access panels. f.

2024004.1 SECTION 10 26 23
Richard L. Johnson Early Education Center Renovation DECORATIVE WALL PROTECTION PANELS

Richard L. Johnson Early Education Center Renovation Phase 2

Bartholomew Consolidated School Corporation

3. Show operation of hinged and sliding components covered by or adjacent to resin infused composite wall panels.

B. Qualification Data: For Installer.

1.05 CLOSEOUT SUBMITTALS

A. Maintenance Data: For decorative wall panels to include in maintenance manuals. Include manufacturer's written cleaning, stain-removal, instructions.

1.06 QUALITY ASSURANCE

- A. Installer Qualifications: Minimum 3 years' experience, an authorized representative who has experience in installation of systems similar in complexity to those required for this project or approved by manufacturer.
- B. Manufacturer Qualifications: Minimum 5 years' experience in the production of specified products and a record or successful in-service performance.
- C. Product Test Reports: From a qualified independent testing laboratory showing compliance of each component with requirements indicated.

D. Mock-ups:

- 1. Build mockups to verify selections made under submittals and to demonstrate aesthetic effects, set quality for materials and construction, set quality standard for fabrication and installation.
- 2. Acceptable mock-ups may remain as part of the Work if undamaged at time of Substantial Completion.
- 3. Acceptable mock-ups shall be comparison standard for remaining Work.

1.07 DELIVERY, STORAGE, AND HANDLING

- A. Comply with decorative wall panel manufacturers' written instructions for minimum and maximum temperature and humidity requirements for shipment, storage, and handling.
- B. Store materials in original, undamaged packaging in a clean, dry place out of direct sunlight and exposure to the elements. A minimum room temperature of 40°F (4°C) and a maximum of 100°F (38°C) should be maintained.
- C. Materials must be stored flat.

1.08 FIELD CONDITIONS

- A. Materials must be acclimated in an environment of 65-75°F (18-24°C) for at least 24 hours prior to beginning the installation.
- B. Environmental Limitations: Do not install decorative wall panels until spaces are enclosed and weathertight, wet-work in spaces is complete and dry, work at and above ceilings is complete, and ambient temperature and humidity conditions are maintained at the levels indicated for Project when occupied for its intended use.

Bartholomew Consolidated School Corporation

1.09 WARRANTY

- A. Special Warranty: Manufacturer and Installer agree to repair or replace components of resin infused composite wall panels that fail in performance, materials, or workmanship within specified warranty period.
 - 1. Warranty Period: Five years from date of Substantial Completion.

PART 2 - PRODUCTS

2.01 PERFORMANCE REQUIREMENTS

- A. Fire-Test-Response Characteristics: resin infused composite wall systems shall comply with "Surface-Burning Characteristics" or "Fire Growth Contribution" Subparagraph below, or both, as determined by testing identical products by UL or another testing and inspecting agency acceptable to authorities having jurisdiction:
 - 1. Surface-Burning Characteristics: Comply with ASTM E 84 or UL 723; testing by a qualified testing agency on systems prepared according to ASTM E 2573. Identify products with appropriate markings of applicable testing agency.
 - a. Flame-Spread Index: 25 or less.
 - b. Smoke-Developed Index: 450 or less.
 - 2. Fire Growth Contribution: Comply with acceptance criteria of local code and authorities having jurisdiction when tested according to NFPA 286.

2.02 HARD STOP PANEL

- A. Hard Stop Wall Panel System: Basis of design system as indicated below.
 - 1. Manufacturer: Formica Corporation
 - 2. Type: HardStop Decorative Protection Panels.
 - 3. Description: Impact resistant panels.
 - 4. Panel Core Material: Treated fiberglass core. Class A Fire-rate.
 - 5. Laminate Grade: Grade H1, 0.0677 Inches 0.0827 Inches.
 - 6. Laminate Color(s): as indicated on Drawings.
 - 7. Laminate Finish: as indicated on Drawings.
 - 8. Laminate Application(s): Wall panels.

2.03 INSTALLATION MATERIALS

- A. Installation Products: Concealed on back of system, recommended by decorative wall panel manufacturer to support weight of system, and as follows:
 - Fasteners: Manufacturer's standard.

2.04 FABRICATION

A. Fabricate panels to sizes and shapes indicated, in accordance with manufacturer's instructions and approved Shop Drawings.

2024004.1 SECTION 10 26 23
Richard L. Johnson Early Education Center Renovation DECORATIVE WALL PROTECTION PANELS

Richard L. Johnson Early Education Center Renovation Phase 2

Bartholomew Consolidated School Corporation

B. Provide holes and cutouts for mounting of wall-mounted equipment and accessories.

2.05 ACCESSORIES

- A. Aluminum Trim Profiles for Seam Treatments:
 - 1. Thicknesses: All trims 0.055-inch.
 - 2. Profile Types:
 - a. Outside corners.
 - b. End caps.
 - 3. Colors, Finish, and Patterns: as indicated on Drawings.
- B. Adhesive, Seam Filler, and Primer: panels shall be furnished as a complete packaged system, including appropriate standard adhesive, seam filler, and primer.
- C. Bacteria resistant caulk and trims as recommended by Manufacturer.

PART 3 - EXECUTION

3.01 EXAMINATION

- A. Examine materials, substrates, areas, and conditions, with Installer present, for compliance with requirements, installation tolerances, and other conditions affecting performance of resin infused composite wall panels.
- Proceed with installation only after unsatisfactory conditions have been corrected.

3.02 PREPARATION

- Clean surfaces to receive panels; remove loose and foreign matter than could interfere with adhesion.
- B. Measure each area and establish layout of panels and joints of sizes indicated on Drawings within a given area.
- C. Before installation, allow panel to adjust and become stable in spaces where it will be installed according to resin infused composite wall panel manufacturer's written instructions. Acclimatize panels for minimum of 48 hours at ambient temperature and humidity conditions indicated for spaces when occupied for their intended use.

3.03 INSTALLATION

- A. Install the work of this section in strict accordance with the manufacturer's recommendations using approved adhesive. Note there are special installation instructions for non-standard conditions: radius walls, tile, CMU block, etc.
- B. Temperature at the time of installation must be between 65-75°F (18-24°C) and be maintained for at least 48 hours after the installation to allow for proper adhesive set-up.
- C. Provide templates and rough-in measurements.

2024004.1 SECTION 10 26 23

Richard L. Johnson Early Education Center Renovation Phase 2

Bartholomew Consolidated School Corporation

 Accessory Materials: Install in accordance with manufacturer's written installation instructions.


DECORATIVE WALL PROTECTION PANELS


- E. Relative humidity shall not exceed 80%.
- F. Do not expose wall covering to direct sunlight during or after installation. This will cause the surface temperature to rise, which in turn will cause bubbles and delamination.
- G. Install panels in accordance with manufacturer's instructions and approved Shop Drawings.
- H. Install panels plumb. Align adjacent pieces in same plane.
- I. Install with hairline joints.

3.04 CLEANING

- A. Clean panels on completion of installation to remove dust and other foreign materials according to manufacturer's written instructions.
- B. Do not permit construction near unprotected surfaces.

END OF SECTION

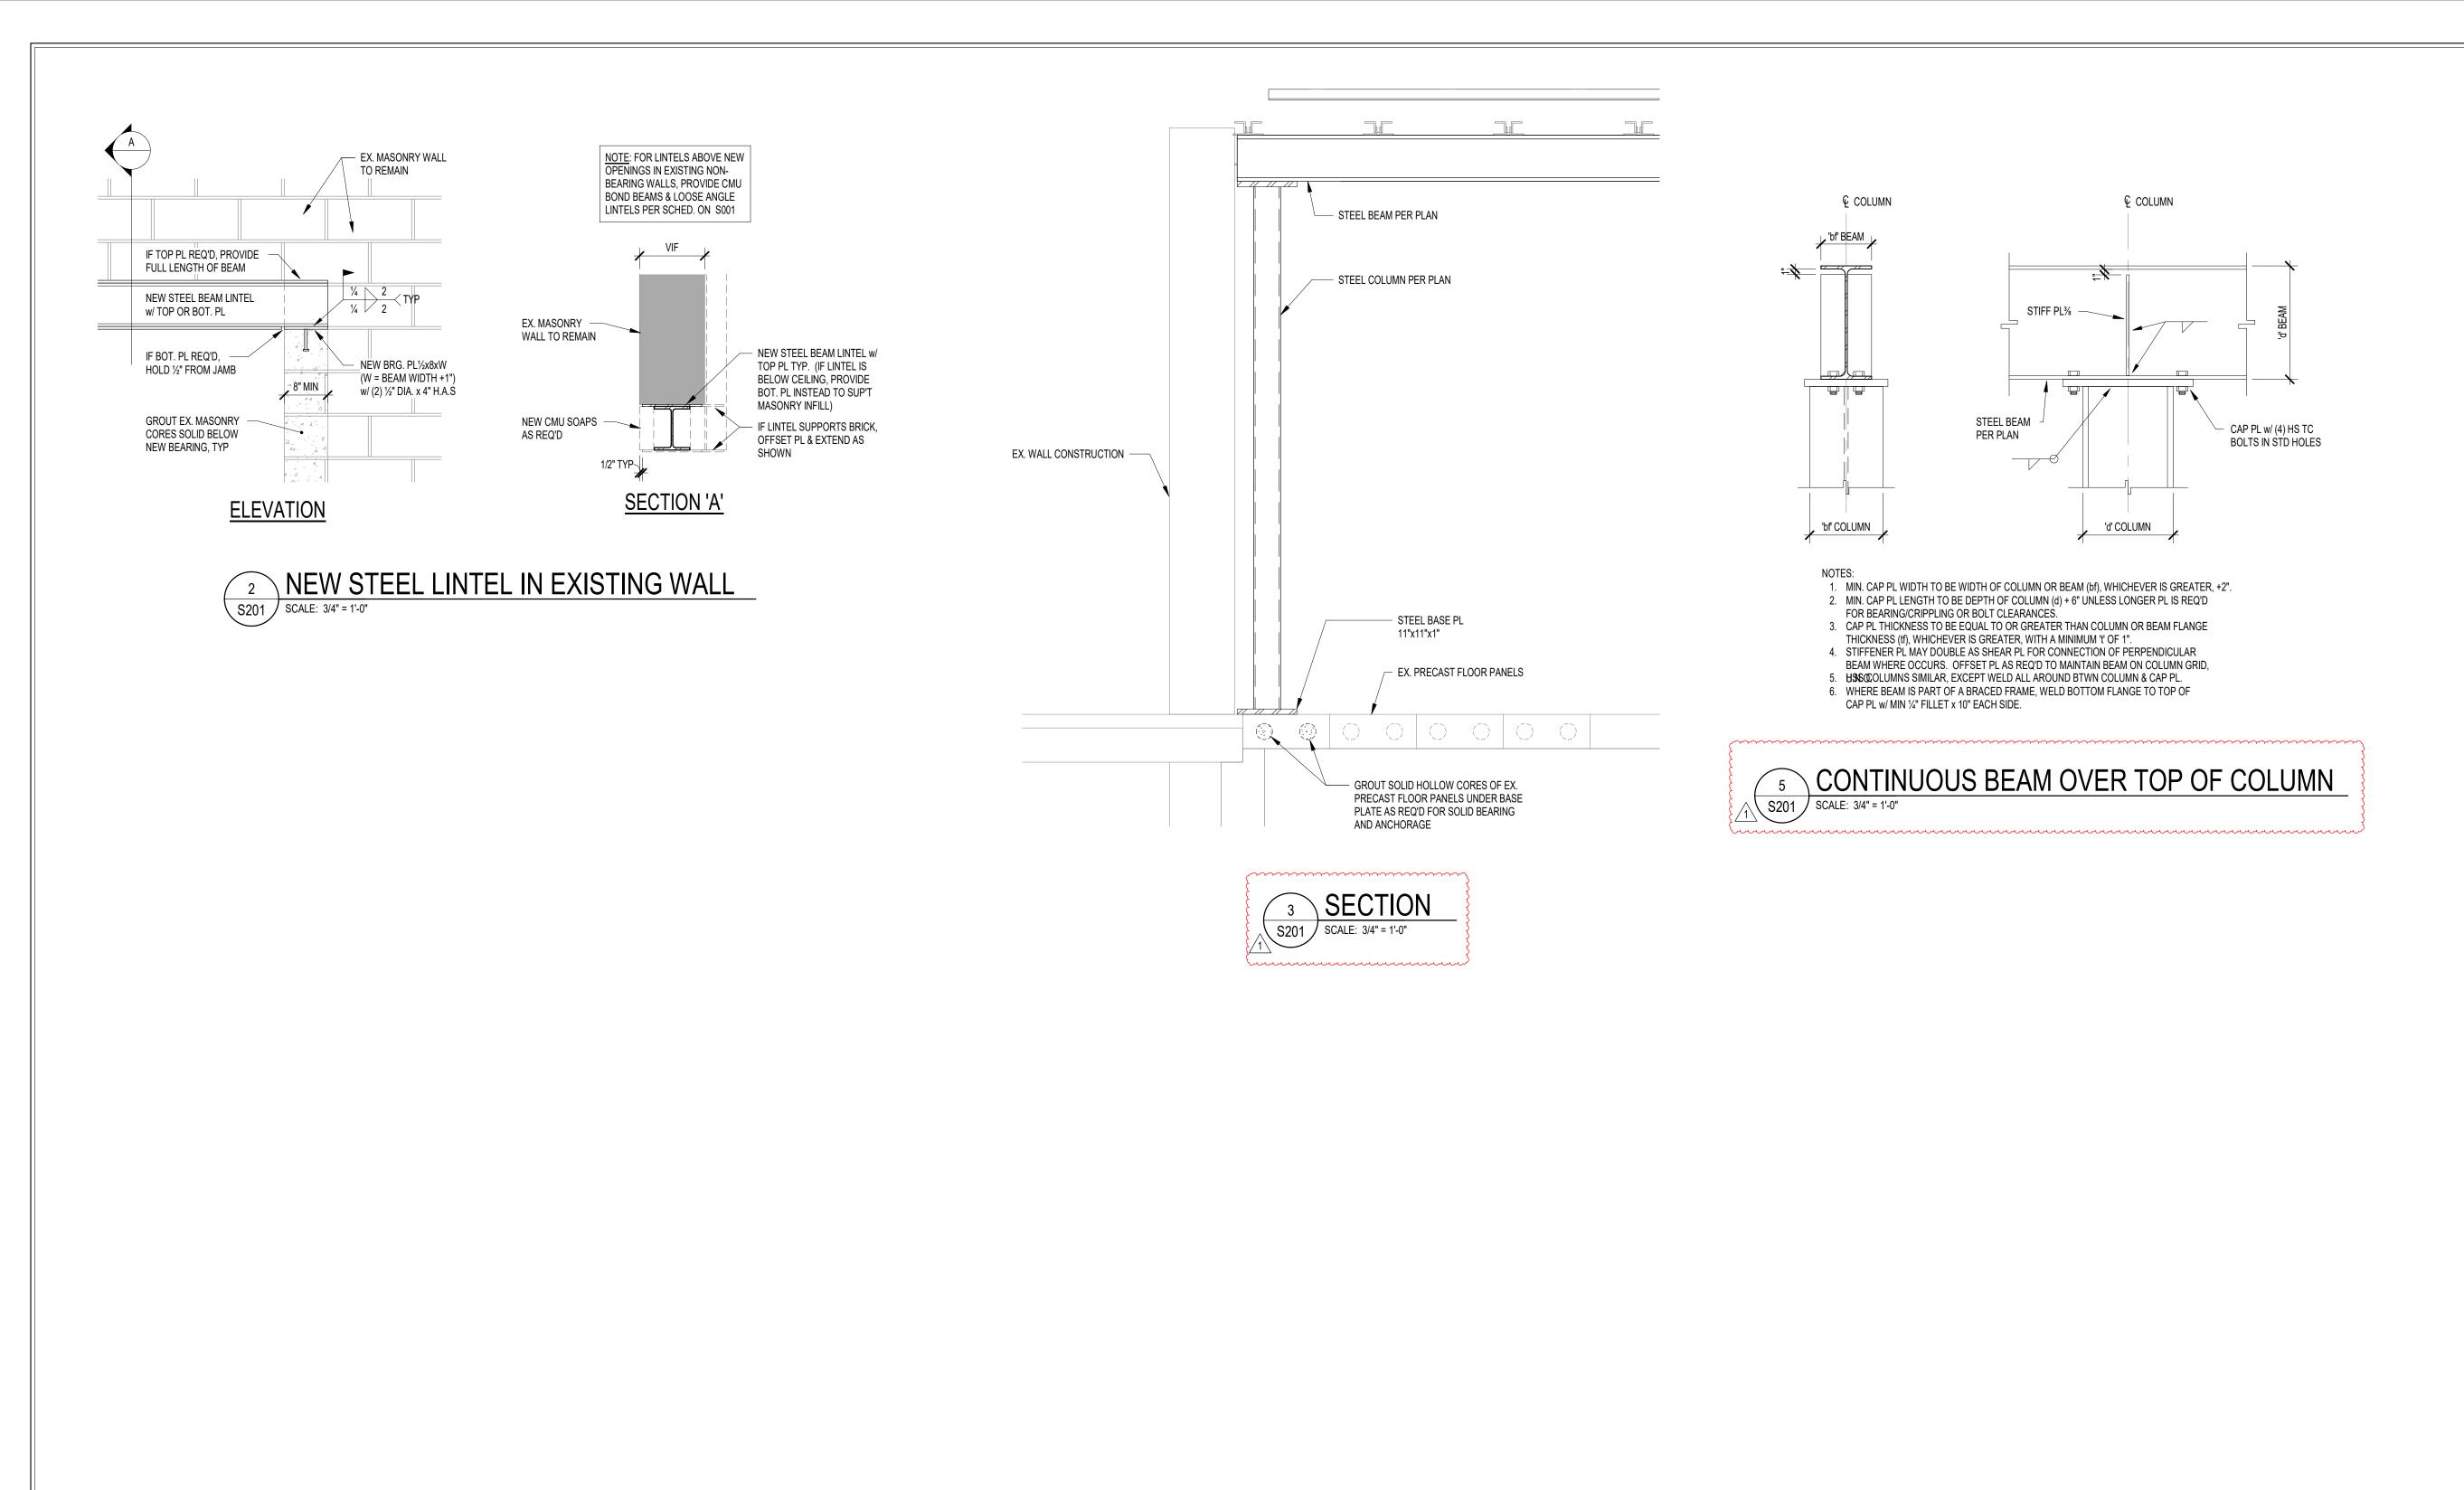

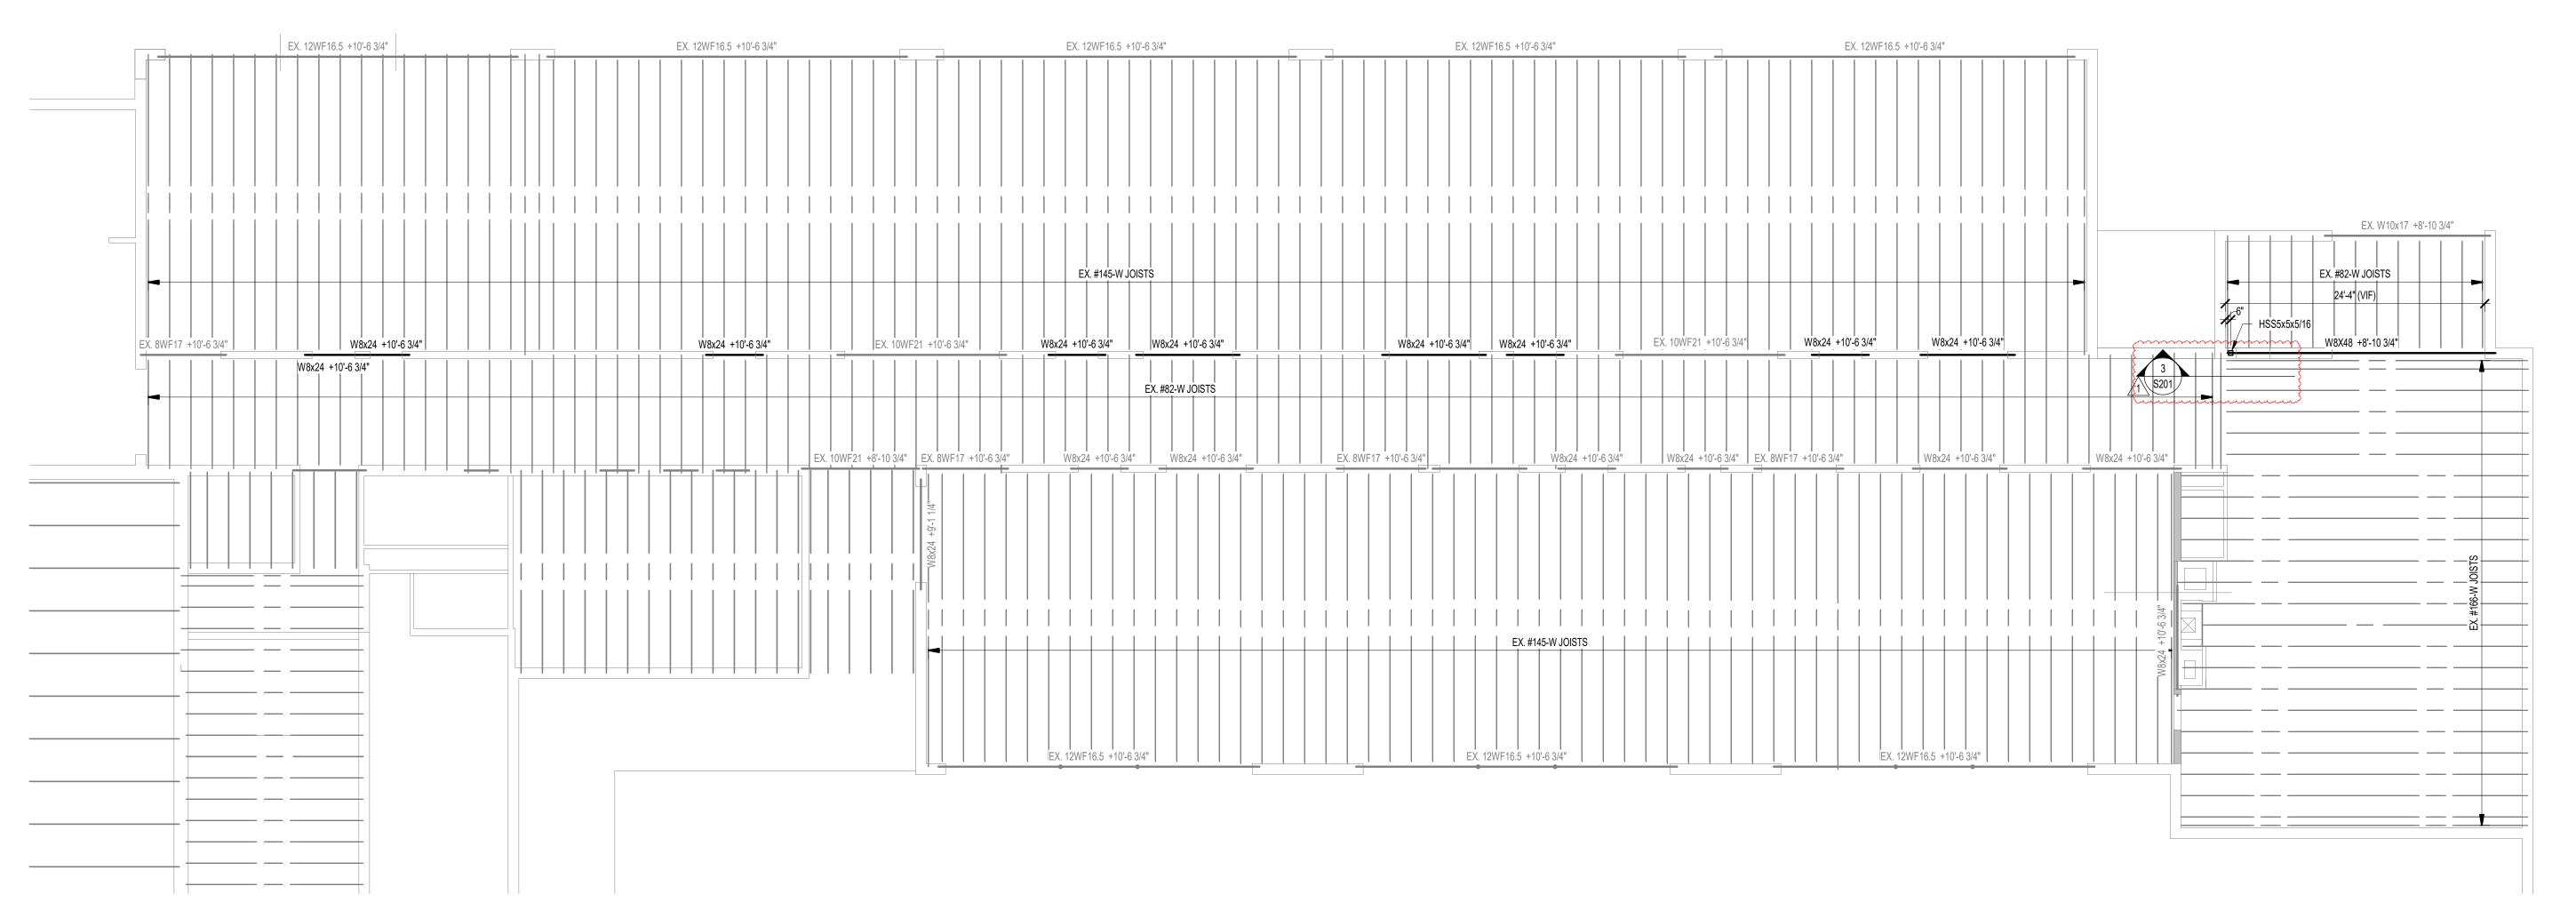

FRAMING PLAN NOTES

- 1. REF. S001 & S002 FOR STRUCTURAL NOTES, DESIGN DATA, SCHEDULES & LEGENDS. 2. REF. THE S400 SERIES FOR TYPICAL FRAMING AND MASONRY DETAILS.
- 3. ALL CONTRACTORS ARE REQUIRED TO COORDINATE THEIR WORK WITH ALL DISCIPLINES TO AVOID CONFLICTS. THE MECHANICAL, ELECTRICAL, AND
- PLUMBING ASPECTS ARE NOT IN THE SCOPE OF THESE DRAWINGS. THEREFORE, ALL REQUIRED MATERIALS AND WORK MAY NOT BE INDICATED. 4. ALL ELEVATIONS ARE REFERENCED FROM THE FIRST FLOOR FIN. FLOOR
- ELEVATION +0'-0".
- 5. <u>ALL WALLS SHALL BE LAID OUT FROM THE ARCHITECTURAL DRAWINGS.</u> 6. REF. ARCH. DRAWINGS. FOR ALL DIMENSIONS NOT SHOWN. CONTRACTOR
- SHALL VERIFY ALL DIMENSIONS PRIOR TO CONSTRUCTION AND IMMEDIATELY NOTIFY ARCHITECT/ENGINEER OF ANY DISCREPANCIES.
- 7. COORDINATE EXACT SIZE & LOCATION OF ANY MECHANICAL OPENINGS IN FLOOR SLAB, ROOF DECK, OR WALLS WITH THE MEP CONTRACTOR(S). LOCATION & SIZE OF ALL DUCT OPENINGS, GRILLES, ETC. SHALL BE

VERIFIED PRIOR TO CONSTRUCTION.

- 8. ALL ELEVATIONS SHOWN ON PLAN INDICATE TOP OF STEEL BEAM UNLESS NOTED OTHERWISE.
- 9. PROVIDE FRAMES AT ALL ROOF DRAINS, ROOF HATCHES & OTHER ROOF OPENINGS PER TYPICAL DETAILS ON S403. COORD. EXACT NUMBER, LOCATIONS &
- DIMENSIONS WITH THE APPROPRIATE CONTRACTORS & THE ARCH. & MEP DWGS. 10. PROVIDE CMU REINFORCING AS NOTED ON PLANS. IF NOT SHOWN ON PLANS, MINIMUM CMU WALL REINFORCING TO BE #5 VERTS @ 48" O.C. PROVIDE
- OPEN-CORE BOND BEAMS AT TOPS OF WALLS, AT CHANGES IN CMU THICKNESS, AND WHERE INDICATED ON PLANS & SECTIONS (10'-0" O.C. MAX VERTICAL SPACING). PROVIDE 1/2 OF INTERRUPTED VERTICALS AT JAMBS OF OPENINGS AND PROVIDE ADDITIONAL VERT'S. AT ENDS OF WALLS.
- 11. ACOUSTICAL CMU PANELS TO BE REGARDED AS WALL OPENINGS FOR THE PURPOSES OF HORIZONTAL BOND BEAM REINFORCING: PROVIDE BOND BEAMS IMMEDIATELY ABOVE AND BELOW PANELS. VERTICAL REINFORCING
- TO BE CONTINUOUS THROUGH ACOUSTICAL CMU PANELS. 12. ALL MASONRY BOND BEAMS, OTHER THAN BOND BEAM LINTELS OVER
- OPENINGS, SHALL BE "OPEN-CORE" BOND BEAMS TO ALLOW VERTICAL REINFORCING TO PASS THROUGH, UNLESS NOTED OTHERWISE.
- 13. REF. ARCH. DWGS. FOR MASONRY CONTROL & EXPANSION JOINT LOCATIONS. 14. ALL HORIZONTAL AND DIAGONAL BRIDGING FOR STEEL JOISTS SHALL BE DESIGNED,
- LOCATED & PROVIDED BY THE JOIST SUPPLIER PER SJI SPECIFICATIONS. 15. PLAN LEGEND:
 - DENOTES FIN. FLOOR DENOTES TOP OF STEEL, SLAB, ETC. DENOTES BOTTOM OF LINTEL, ETC.
 - DENOTES SLAB EDGE DIMENSION MEASURED FROM BEAM OR COLUMN CENTERLINE
 - DENOTES DECK EDGE ANGLE DIMENSION MEASURED FROM BEAM OR COLUMN CENTERLINE DENOTES BEAM BEARING PLATE ON CMU WALL
 - DENOTES BEAM-TO-COLUMN MOMENT CONNECTION. REF. DETAILS ON S405.
 - DENOTES BEAM-THRU-BEAM MOMENT CONNECTION. REF. DETAILS ON S404. DENOTES BRACED FRAME OR KICKER LOCATION DENOTES APPROX. LOCATION OF OPENING IN

DECK/SLAB. REF. DETAILS ON S404 FOR TYPICAL

POSITIVE CAMBER TO

- OPENING FRAMES. 18. WIDE-FLANGE BEAM & GIRDER NOTATION: BEAM REACTIONS SHOWN IN KIPS TO BE USED FOR DESIGN OF SHEAR CONNECTION BY STEEL FABRICATOR'S SSE (ALLOWABLE STRESS DESIGN / LOADS UNFACTORED).
- REF. THE STEEL CONNECTION NOTES ON S001 FOR DESIGN OF CONNECTIONS AT BEAMS & GIRDERS WITH NO REACTION SHOWN. THE MIN. SHEAR CONNECTION DESIGN LOAD SHALL BE 15 KIPS. NO. OF 3/4" DIA. x 37/8" LONG

SHEAR CONNECTOR STUDS


STEEL BEAM SIZE —

OFFSET NON-COMPOSITE SPACED UNIFORMLY ALONG (DEAD LOAD) DEFLECTION FULL LENGTH OF BEAM W16x31 (16) $c = \frac{3}{4}$ "

> DENOTES BEAM REACTION IN KIPS (SEE NOTES ABOVE) TYPICAL COMPOSITE BEAM DIAGRAM





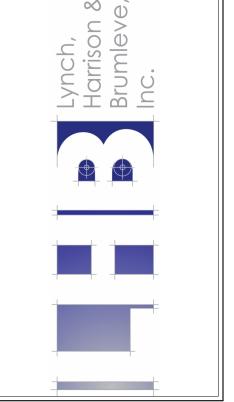

S O

SCOPE DRAWINGS:

These drawings indicate the general scope of the project in terms of architectural design concept, the dimensions of the building, the major architectural elements and the type of structural, mechanical and electrical systems.

The drawings do not necessarily indicate or describe all work reguired for full performance and completion of the

REVISIONS: ADD #1 12/04/24


the trade contractors shall furnish all items required for the proper execution and completion of the work.

ISSUE DATE | DRAWN BY | CHECKED BY

NMA

11/21/2024

DRAWING TITLE:

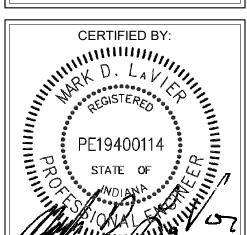

DRAWING NUMBER S201



8831 Keystone Crossing, Indianapolis, IN 46240

BARTHOLOMEW COUNTY SCHOOL
CORPORATION
RENOVATIONS TO
AICHARD L. JOHNSON EEC
1209 S SYCAMORE ST, COLUMBUS, IN 47201

SCOPE DRAWINGS:

These drawings indicate the general scope of the project in terms of architectural design concept, the dimensions of the building, the major architectural elements and the type of structural, mechanical and electrical systems.

The drawings do not necessarily indicate or describe all work required for full performance and completion of the requirements of the Contract.


On the basis of the general scope indicated or described, the trade contractors shall furnish all items required for the proper execution and completion of the work.

REVISIONS:

ISSUE DATE DRAWN BY CHECKED BY

11/20/2024 JAG ECN

OVERALL FLOOR PLANS

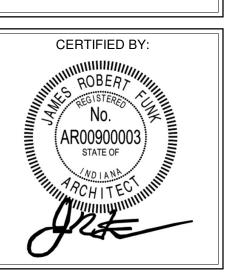

A101

BUILDING CODE ANALYSIS

OCCUPANCY TYPE E TYPE OF CONSTRUCTION II-B, ONE STORY

SPRINKLER SYSTEM
NO AUTOMATIC FIRE SUPRESSION SYSTEM

CODE SUMMARY

EXISTING CODE CONDITIONS. EXISTING 1952 BUILDING WITH NO ADDITIONAL SQUARE FOOTAGE ADDED. NO CHANGE IN OCCUPANCY. EXISTING SCHOOL HAS CORRIDOR SMOKE DETECTION SYSTEM.
FIRE ALARM SYSTEMS (HORNS AND STROBES) WILL BE EXTENDED INTO THE CLASSROOMS.

ACTUAL FLOOR AREA

<u>ACTUAL FL</u>	OOR AREA			
	AREA SUMMARY	EXISTING/ RENOVATED	NEW CONSTRUCTION	TOTAL
	GROUND FLOOR	20,833 SF	0 SF	20,833
	TOTAL FLOOR AREAS	20,833 SF	0 SF	20,833
FGRESS				

NUMBER OF EXITS: NEW ROOMS ARE REQUIRED TWO MENAS OF EGRESS WHEN:

	AREA	OCCUPANTS	LOAD FACTORS	COMMON PATH OF TRAVEL
CLASSROOMS	>1,000 SF	>50	35 SF/PERSON	>75 FEET
BUSINESS	>5,000 SF	>50	100 SF/PERSON	>100 FEET
ASSEMBLY	>350 OR 750 SF	>50	7 OR 15 SF/PERSON	>75 FEET

EGRESS CAPACITY: 0.15 INCHES PER PERSON AT DOORS

TRAVEL DISTANCE: TABLE 1016.2, IBC LIMITS THE MAXIMUM TRAVEL DISTANCE IN A NON-SPRINKLED BUILDING E OCCUPANCY 200 FEET

DOOR SWING: DOORS SERVING AN AREA CONTAINING AN OCCUPANT LOAD OF 50 OR MORE PERSONS SHALL SWING IN THE DIRECTION OF EGRESS TRAVEL (SECTION 1008.1.2. IBC)

FIRE RESISTANCE RATING REQUIREMENTS FOR BUILDING ELEMENTS

(RATINGS IN HOURS FOR TYPE II-B)	
BUILDING ELEMENT:	MINIMUM FIRE RESISTANCE:
BEAMS	0 (TABLE 601)
COLUMNS	0 (TABLE 601)
EXTERIOR BEAMING WALLS	0 (TABLE 601)
EXTERIOR NON-BEARING WALLS	$X < 30 = 0$; $10 \le X = 0$ (TABLE 601 & 602)
INTERIOR BEARING WALLS (PARTITIONS)	0 (TABLE 601 AND SEC 602.2)
FLOOR CONSTRUCTION	0 (TABLE 601)
ROOF CONSTRUCTION	0 (TABLE 601)

TOTAL OCCUPANTS TOTAL DOOR REQUIRED WIDTH: 69.45 INCHES STANDARD DOOR = 463 x 0.15 = 69.45 INCHES TOTAL DOOR WIDTH PROVIDED: 830 INCHES

<u>SPACE</u>

CLASSROOMS

ADMINISTRATION

MULTIPURPOSE

TEACHER WORK SPACES

STORAGE, COATS, MECH., ETC.

FIRST FLOOR EGRESS ANALYSIS

CODE O.L.

APPLICABLE CODES AND STANDARDS

CORRIDORS

STAIRWAYS

INDIANA BUILDING CODE - 2014 (2012 INTERNATIONAL BUILDING CODES & STATE AMENDMENTS) INDIANA FIRE CODE - 2014 (2012 INTERNATIONAL FIRE CODES & STATE AMENDMENTS) INDIANA ELECTRICAL CODÈ - 2009 (2008 NFPA 70 & STATE AMENDMENTS) INDIANA MECHANICAL CODE - 2014 (2012 INTERNATIONAL MECHANICAL CODE & STATE AMENDMENTS) INDIANA MECHANICAL CODE - 2014 (2012 INTERNATIONAL MECHANICAL CODE & STATE AMENDMENTS)
INDIANA PLUMBING CODE - 2012 (2006 INTERNATIONAL PLUMBING CODES & STATE AMENDMENTS)
INDIANA ELEVATOR CODE - 2011 (ASME A17.1 - 2007 WITH STATE AMENDMENTS)
INDIANA ACCESSIBILITY CODE - (2014 I.B.C., CHAP. 11 (ANSI 117.1-2009))
INDIANA ENERGY CONSERVATION CODE - 2010 (ASHRAE 90.1 2007 EDITION WITH STATE AMENDMENTS)
NFPA 10 - 2010 EDITION, PORTABLE FIRE EXTINGUISHERS
NFPA 13 - 2010 EDITION, INSTALLATION OF SPRINKLER SYSTEMS
NFPA 72 - 2010 EDITION, NATIONAL FIRE ALARM CODE
GENERAL ADMINISTRATION BILLES (675 IAC 12)

GENERAL ADMINISTRATION RULES (675 IAC 12) AMERICANS WITH DISABILITIES ACT (FEDERAL LAW) JULY 26, 1992

0 (TABLE 1018.1)

EXCEPTION 9)

UNENCLOSED STAIRWAYS SHALL

BE PERMITTED (SEC 1020.1,

LIFE SAFETY LEGEND **EGRESS LEGEND** ROOM NAME ROOM NAME XXXX ROOM NUMBER 842 SF ROOM SIZE 20 EGRESS REQUIREMENT PER IBC TABLE 1004.1.2 — CODE OCCUPANT LOAD / CAPACITY —— ACCESSORY OCCUPANT LOAD / CAPACITY ACCESSORY SPACE OCCUPANCY (1) 3'-0" DOOR (33.2" CLEAR WIDTH) A (0.2" PER OCC. = 166 OCC. PR. 3'-0" DOOR (66.4" CLEAR WIDTH) AT 0.2" PER OCC. = 332 OCC. 3 PR. 4'-0" DOOR (45.2" CLEAR WIDTH) AT 0.2" PER OCC. = 226 OCC. DIRECTION OF PATH — DISTANCE TO EXIT **BUILDING CODE LEGEND** 1 HOUR FIRE BARRIER 2 HOUR FIRE BARRIER FIRE EXTINGUIHER AND CABINET FIRE EXTINGUISHER AND BRACKET AUTOMATED EXTERNAL DEFIBRILLATOR

STORAGE PRE-K DIRECTOR EARLY CHILDHOOD CLASSROOM 3s 16 690 SF 35 20 130'-0" DIRECTOR'S OFFICE - NON-RATED -39 2384 SF 15 159 0



OE

SCOPE DRAWINGS:

These drawings indicate the general scope of the project in terms of architectural design concept, the dimensions of the building, the major architectural elements and the type of structural, mechanical and electrical systems.

The drawings do not necessarily indicate or describe all work required for full performance and completion of the requirements of the Contract.

On the basis of the general scope indicated or described the trade contractors shall furnish all items required for the proper execution and completion of the work.

REVISIONS:

ISSUE DATE | DRAWN BY | CHECKED BY

DRAWING TITLE: LIFE SAFETY

JAG


11/20/2024

CERTIFIED BY:

DRAWING NUMBER PROJECT NUMBER

2024004.1

1 FIRST FLOOR LIFE SAFETY PLAN
SCALE: 1/8" = 1'-0"

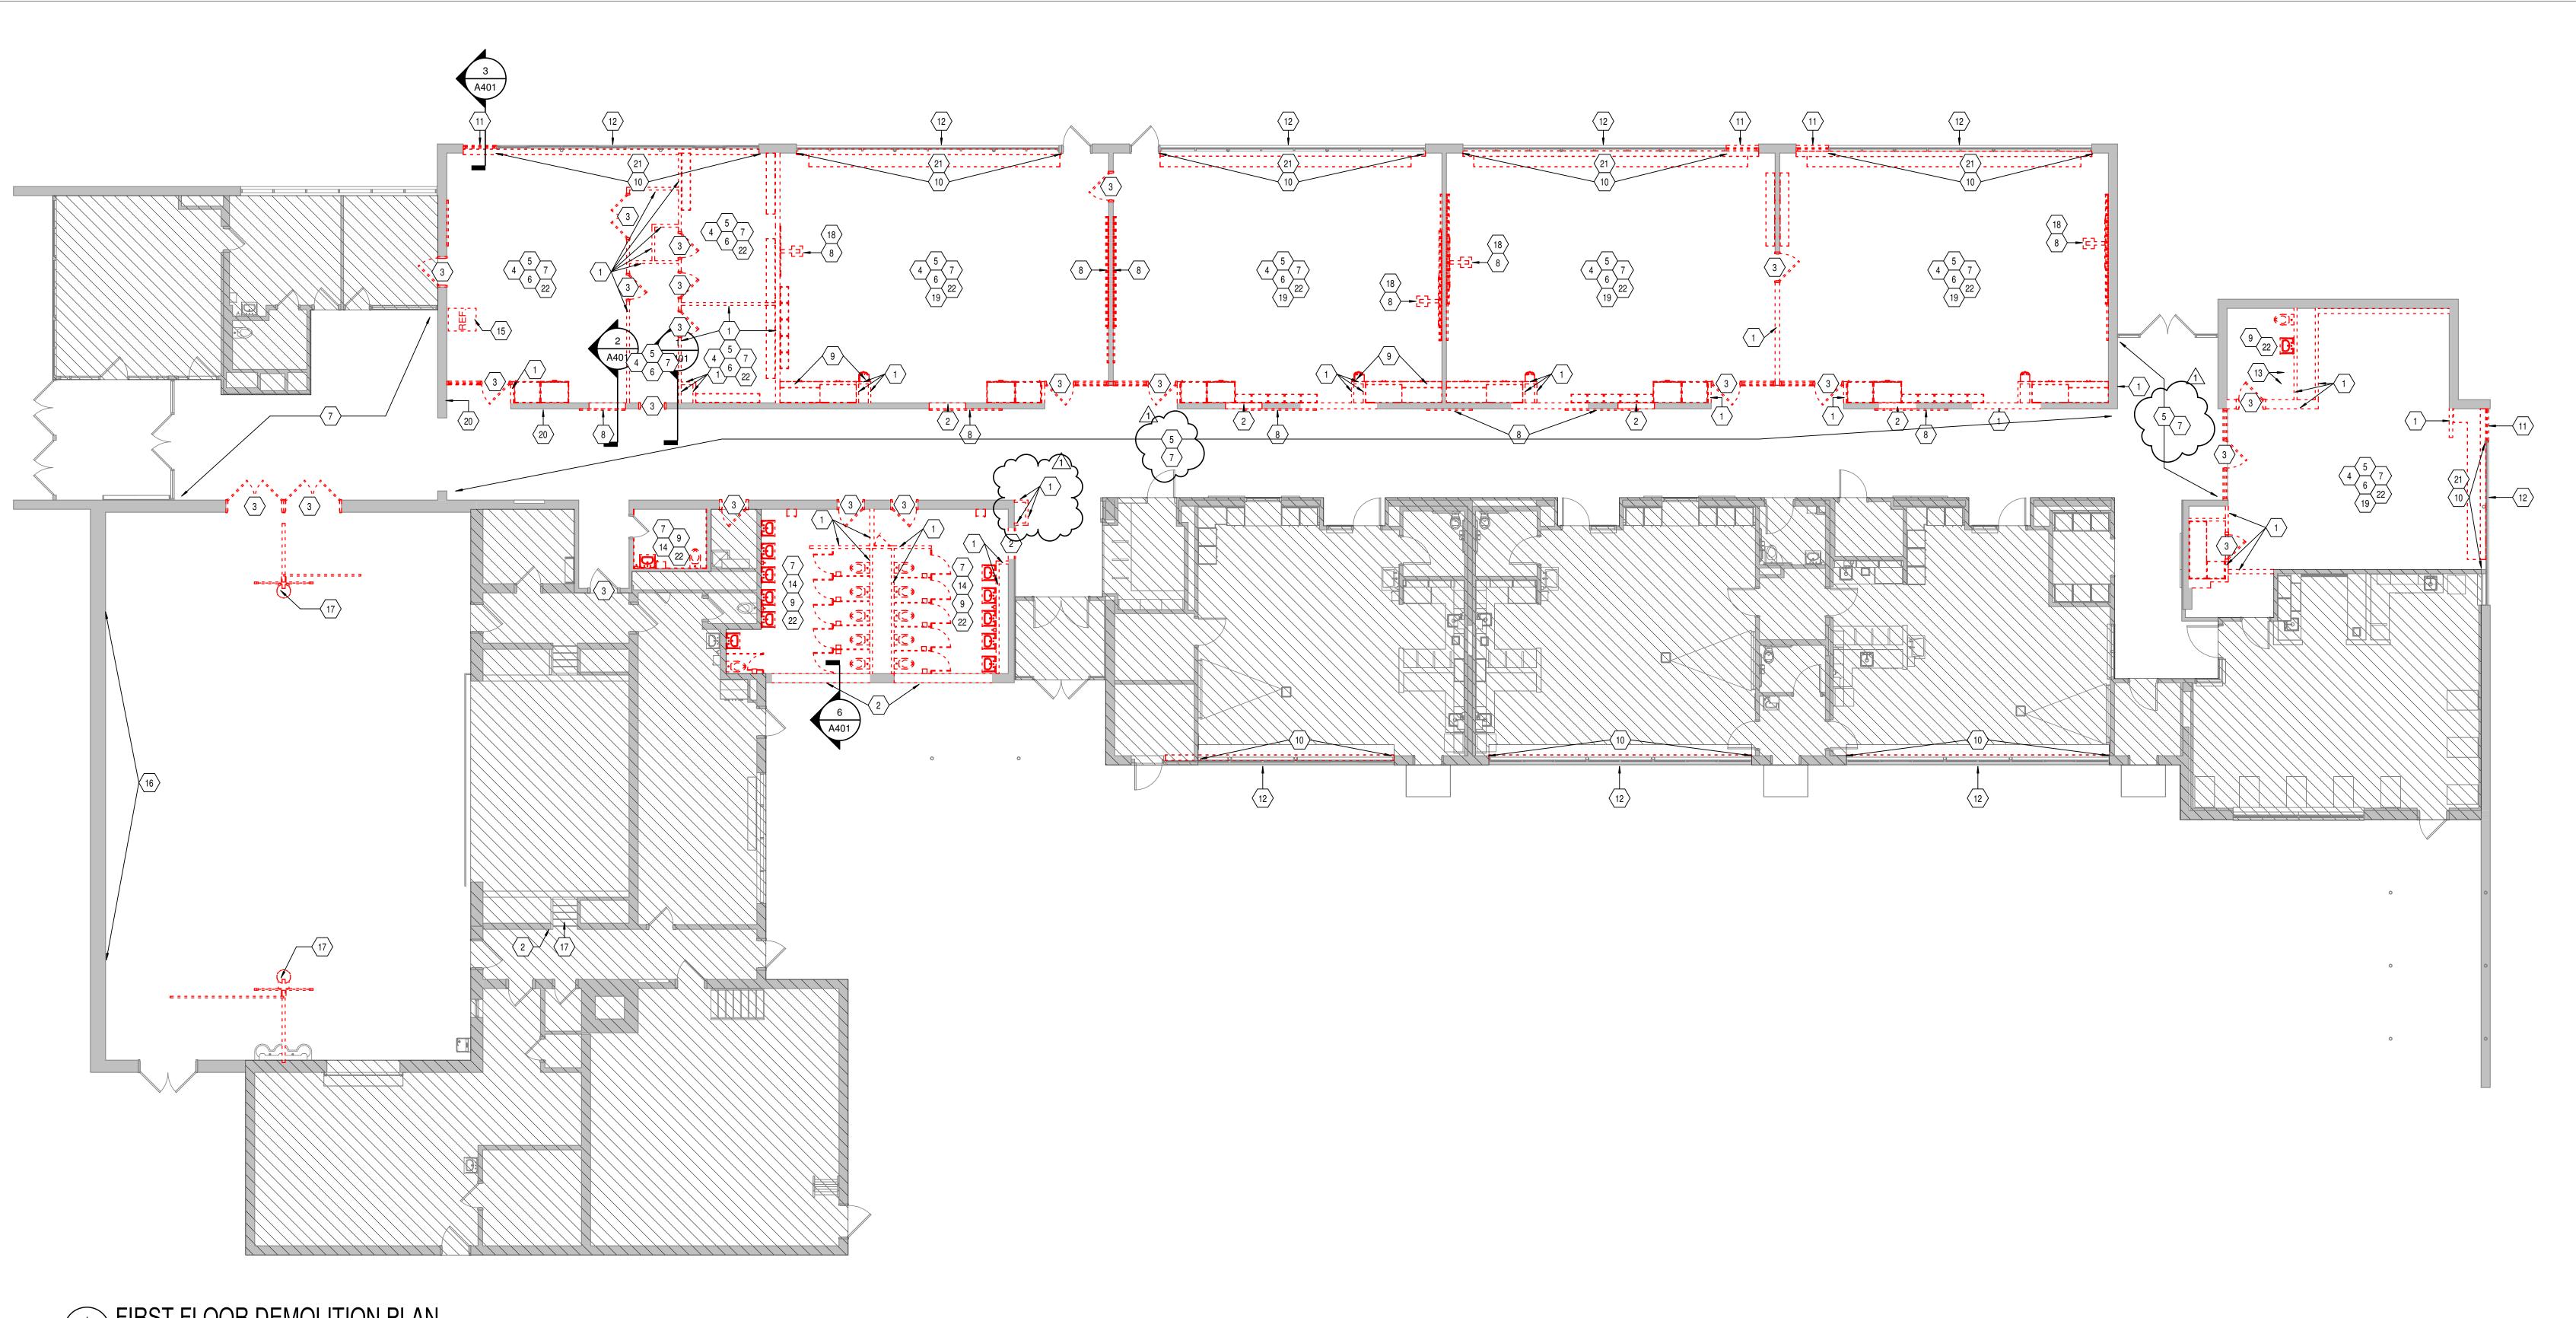

1 FIRST FLOOR DEMOLITION PLAN

SCALE: 1/8" = 1'-0"

DEMOLITION NOTES

1 REMOVE INTERIOR WALL AS INDICATED/REQUIRED FOR NEW WORK. 2 REMOVE PORTION OF MASONRY OR STUD WALL AS REQUIRED FOR INSTALLATION

- OF NEW DOOR AND/OR BORROWED LITE AND LINTEL. 3 REMOVE DOOR, FRAME, AND HARDWARE COMPLETE.
- 4 REMOVE CASEWORK COMPLETE.
- 5 REMOVE SUSPENDED CEILING COMPLETE. 6 REMOVE EXISTING CIELING TILES. 7 REMOVE FLOORING, BASE FINISH, AND ADHESIVE COMPLETE. PATCH AND PREP
- SURFACES FOR NEW FINISHES. 8 REMOVE VISUAL DISPLAY BOARD COMPLETE.
- 9 REMOVE PLUMBING FIXTURES COMPLETE. COORDINATE WITH MEP DOCUMETNS. 10 REMOVE EXISTING WINDOW STOOL COMPLETE. 11 REMOVE PORTION OF WINDOW FOR NEW OPENING. SALVAGE EXISITNG BRICK TO
- INFILL LOUVERS. 12 REMOVE EXTERIOR LOUVERS.
- 13 PROTECT AND SALVAGE EXISTING WASHER DRYER. PREP FOR REINSTALLATION. 14 REMOVE EXISTING TOILET PARTITIONS AND/OR TOILET ROOM ACCESSORIES
- COMPLETE. PATCH AND PREP WALLS FOR NEW FINISH.
- 15 VENDING TO BE TURNED OVER TO OWNER. 16 REMOVE CLERESTORY WINDOW AND FRAME COMPLETE.
- 17 REMOVE BASKETBALL GOALS COMPLETE. 18 REMOVE SMARTBOARDS AND TURN OVER TO SCHOOL.
- 19 REMOVE SPEAKER SYSTEM COMPLETE. COORDINATE WITH MEP DOCUMENTS. 20 RELOCATE ELECTRICAL BOX. COORDINATE WITH MEP DOCUEMENTS.
- 21 REMOVE BLINDS COMPLETE. COORDINATE WITH SCHOOL.
- 22 REMOVE ALL CEILING TO EXPOSE STRUCTURE.

GENERAL DEMOLITION NOTES

- A. HEAVY DASHED LINES INDICATE STRUCTURE, WALLS AND ITEMS TO BE DEMOLISHED UNLESS NOTED OTHERWISE.

 B. SOLID LINES INDICATE STRUCTURE, WALLS, & ITEMS TO REMAIN,
- UNLESS NOTED OTHERWISE.
- C. PROTECT ALL FINISHES, EQUIPMENT & OTHER ITEMS TO REMAIN. WHERE DAMAGE OCCURS, PATCH AND REPAIR OR OTHERWISE RESTORE TO ITS ORIGINAL CONDITION OR REPLACE. D. CONTRACTOR SHALL FIELD VERIFY ALL EXISTING CONSTRUCTION
- AND RELATED CONDITIONS PRIOR TO STARTUP OF DEMOLITION OR NEW CONSTRUCTION.
- E. COORDINATE EXTENTS AND EXACT DIMENSIONS WITH EXTENTS AND EXACT DIMENSIONS OF NEW WORK.
- F. ANY AND ALL DISCREPANCIES SHALL BE BROUGHT TO THE IMMEDIATE ATTENTION OF THE ARCHITECT AND OWNER.
- G. REMOVE ALL MISCELLANEOUS EQUIPMENT ATTACHED TO WALLS, FLOORS AND CEILINGS TO BE DEMOLISHED. COORDINATE WITH THE OWNER FOR ITEMS TO BE SALVAGED OR RE-INSTALLED.
- H. REMOVE ANY ITEMS NOT SPECIFICALLY IDENTIFIED TO BE REMOVED WHICH MUST OBVIOUSLY BE DEMOLISHED TO ACCOMMODATE NEW WORK. VERIFY WITH ARCHITECT. I. ALL OPENINGS, VOIDS, OR DAMAGED SURFACES LEFT BY THE

REMOVAL OF EXISTING CONSTRUCTION, EQUIPMENT, PIPING,

DUCTS, WINDOWS, ETC., SHALL BE PATCHED & REPAIRED TO

MATCH SURROUNDING WORK. PREPARE TO RECEIVE NEW

- FINISHES AS REQUIRED. REMOVE ALL MASTIC, ADHESIVES, FASTENERS AND OTHER MATERIALS WHERE FINISHES (SUCH AS FLOORING, BASE) AND EQUIPMENT (SUCH AS CASEWORK, TACKBOARDS,
- MARKERBOARDS, MECHANICAL ITEMS, ETC.) HAVE BEEN REMOVED AT EXISTING SURFACES TO REMAIN. K. CONSTRUCT DUST AND SOUND CONTROL BARRIERS PRIOR TO THE
- START OF WORK. L. SEE SPECIFICATIONS FOR ASSIGNMENT OF RESPONSIBILITIES PERTAINING TO PATCHING AND REPAIR WORK REQUIRED OF EACH M. DEMOLITION WORK TO BE COMPLETED BY MECHANICAL/PLUMBING,
- ELECTRICAL TRADES IS SHOWN ON OTHER SHEETS IN THIS SET OF CONTRACT DOCUMENTS. THIS CONTRACTOR SHALL REVIEW THE DEMOLITION WORK OF OTHER TRADES TO DETERMINE WHERE SUCH WORK COULD AFFECT HIS WORK AND SHALL COORDINATE HIS WORK WITH THE WORK OF ALL OTHER TRADES.
- N. AT NEW OPENINGS IN EXISTING BRICK MASONRY WALLS, TOOTH IN BRICK TO MATCH EXISTING.

MATCH TEXTURE OF SURROUNDING SURFACES. PROVIDE BLOCK FILLER AS REQUIRED AND PATCH MOUNTING HOLES COMPLETE.

- O. AT NEW OPENINGS IN EXISTING CONCRETE MASONRY WALLS, TOOTH IN NEW CMU TO MATCH EXISTING. P. WHERE EXISTING SURFACE MOUNTED VISUAL DISPLAY BOARDS (MARKER, CHALK, TACK BOARDS) ARE BEING REMOVED FROM WALLS, WALL SURFACE BEHIND BOARD IS TO BE PREPARED TO
- REMOVE PAINT BUILD UP AT BOARD EDGES. Q. CONTRACTOR IS RESPONSIBLE FOR PREP WORK REQUIRED FOR FLOOR SLAB TO RECEIVE NEW FINISHES. PREP WORK TO INCLUDE: PATCH FLOOR SLAB AT AREAS THAT WILL BE CUT TO ACCOMMODATE NEW PLUMBING LINES OR WHERE CAPPING OF EXISTING LINES BELOW THE SLAB IS REQUIRED AND FILLING IN HOLES IN SLAB WHERE EXISTING MEP HAS BEEN ABANDONED.



These drawings indicate the general scope of the project in terms of architectural design concept, the dimensions of the building, the major architectural elements and the type of structural, mechanical and electrical systems.

The drawings do not necessarily indicate or describe all work required for full performance and completion of the requirements of the Contract.

On the basis of the general scope indicated or described, the trade contractors shall furnish all items required for the the trade contractors shall furnish all items required for the proper execution and completion of the work.

SCOPE DRAWINGS:


REVISIONS: ADDENDUM #1 12-03-2024

ISSUE DATE | DRAWN BY | CHECKED BY 11/20/2024 JAG ECN

> DRAWING TITLE: FIRST FLOOR

CERTIFIED BY:

DRAWING NUMBER

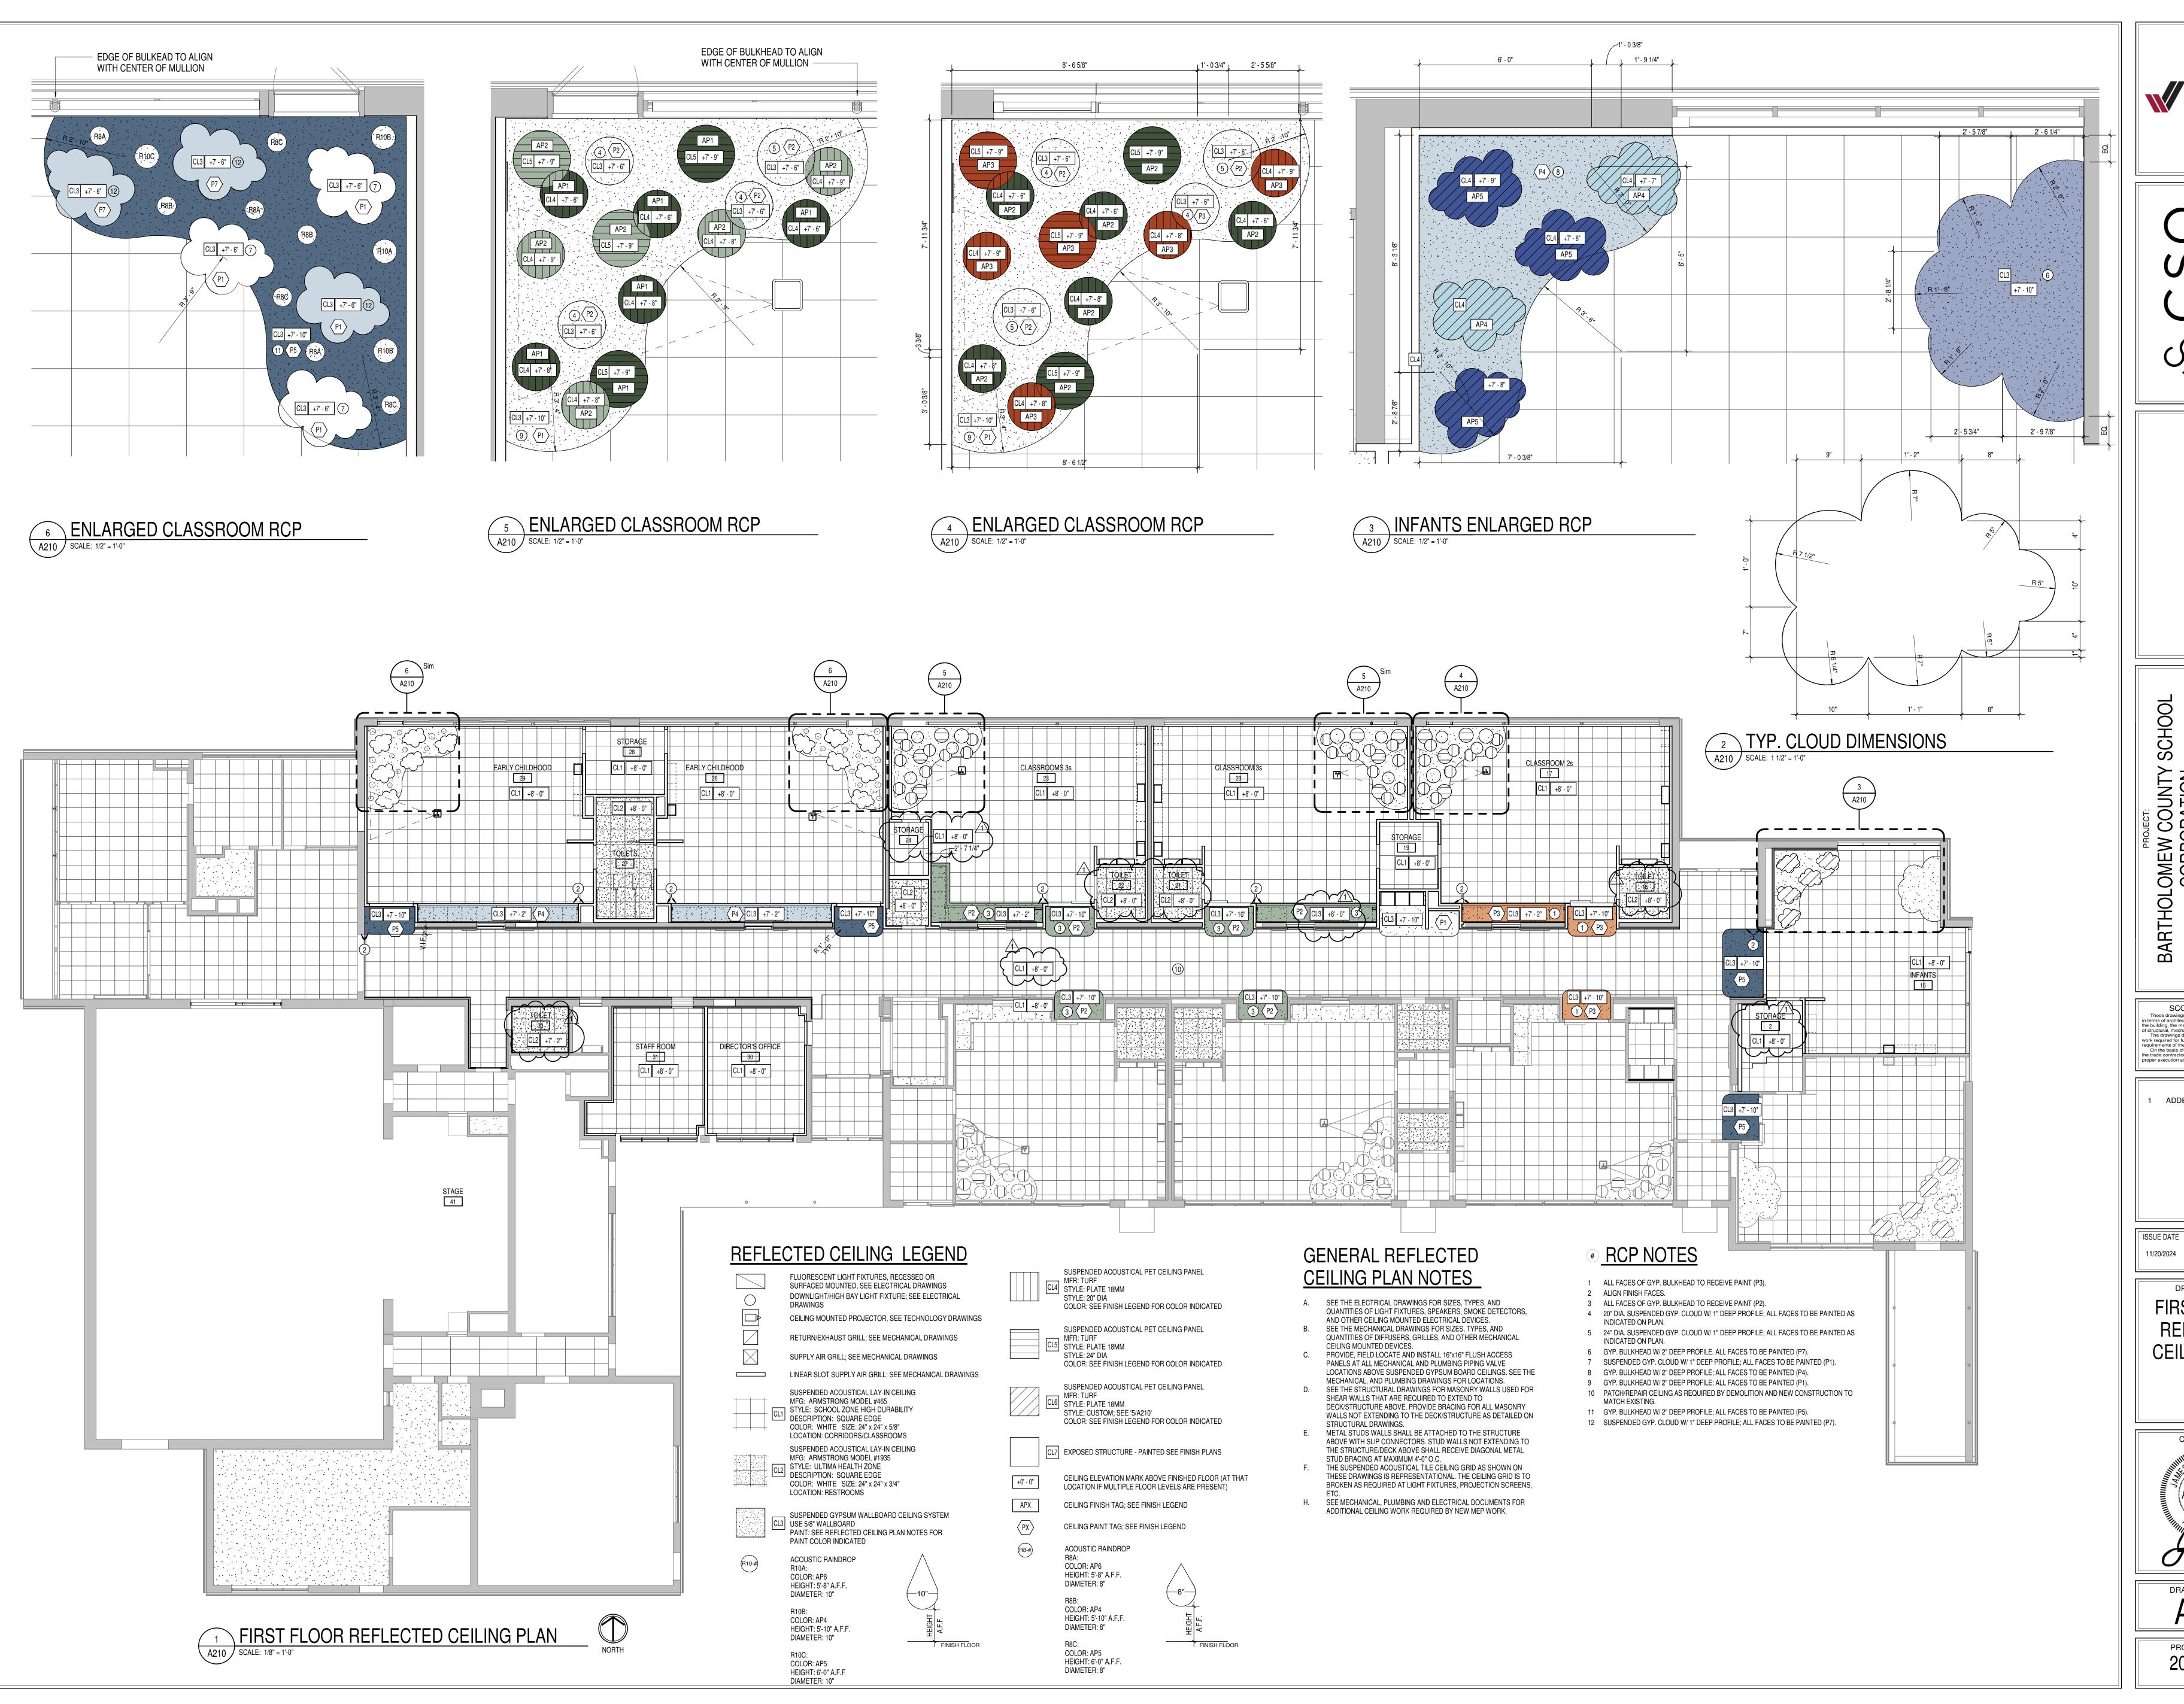

WBCSC TOGETHER WE LEARN

S831 Keystone Crossing, Indianapolis, IN 46240 317.848.7800 | csoinc.net

BARTHOLOMEW COUNTY SCHOOL CORPORATION
RENOVATIONS TO
A JOHNSON EEC
1209 S SYCAMORE ST, COLUMBUS, IN 47201


SCOPE DRAWINGS:
nese drawings indicate the general scope of the project
ms of architectural design concept, the dimensions of
uilding, the major architectural elements and the type
uctural, mechanical and electrical systems.
ne drawings do not necessarily indicate or describe all
required for full performance and completion of the
ements of the Contract.
In the basis of the general scope indicated or described,
ade contractors shall furnish all items required for the
r execution and completion of the work.

REVISIONS:
ADDENDUM #1 12-03-2024

ISSUE DATE DRAWN BY CHECKED BY
11/20/2024 JAG ECN


FIRST FLOOR
REFLECTED

CEILING PLAN

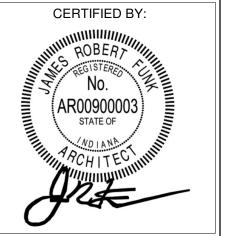

A210

2024004.1

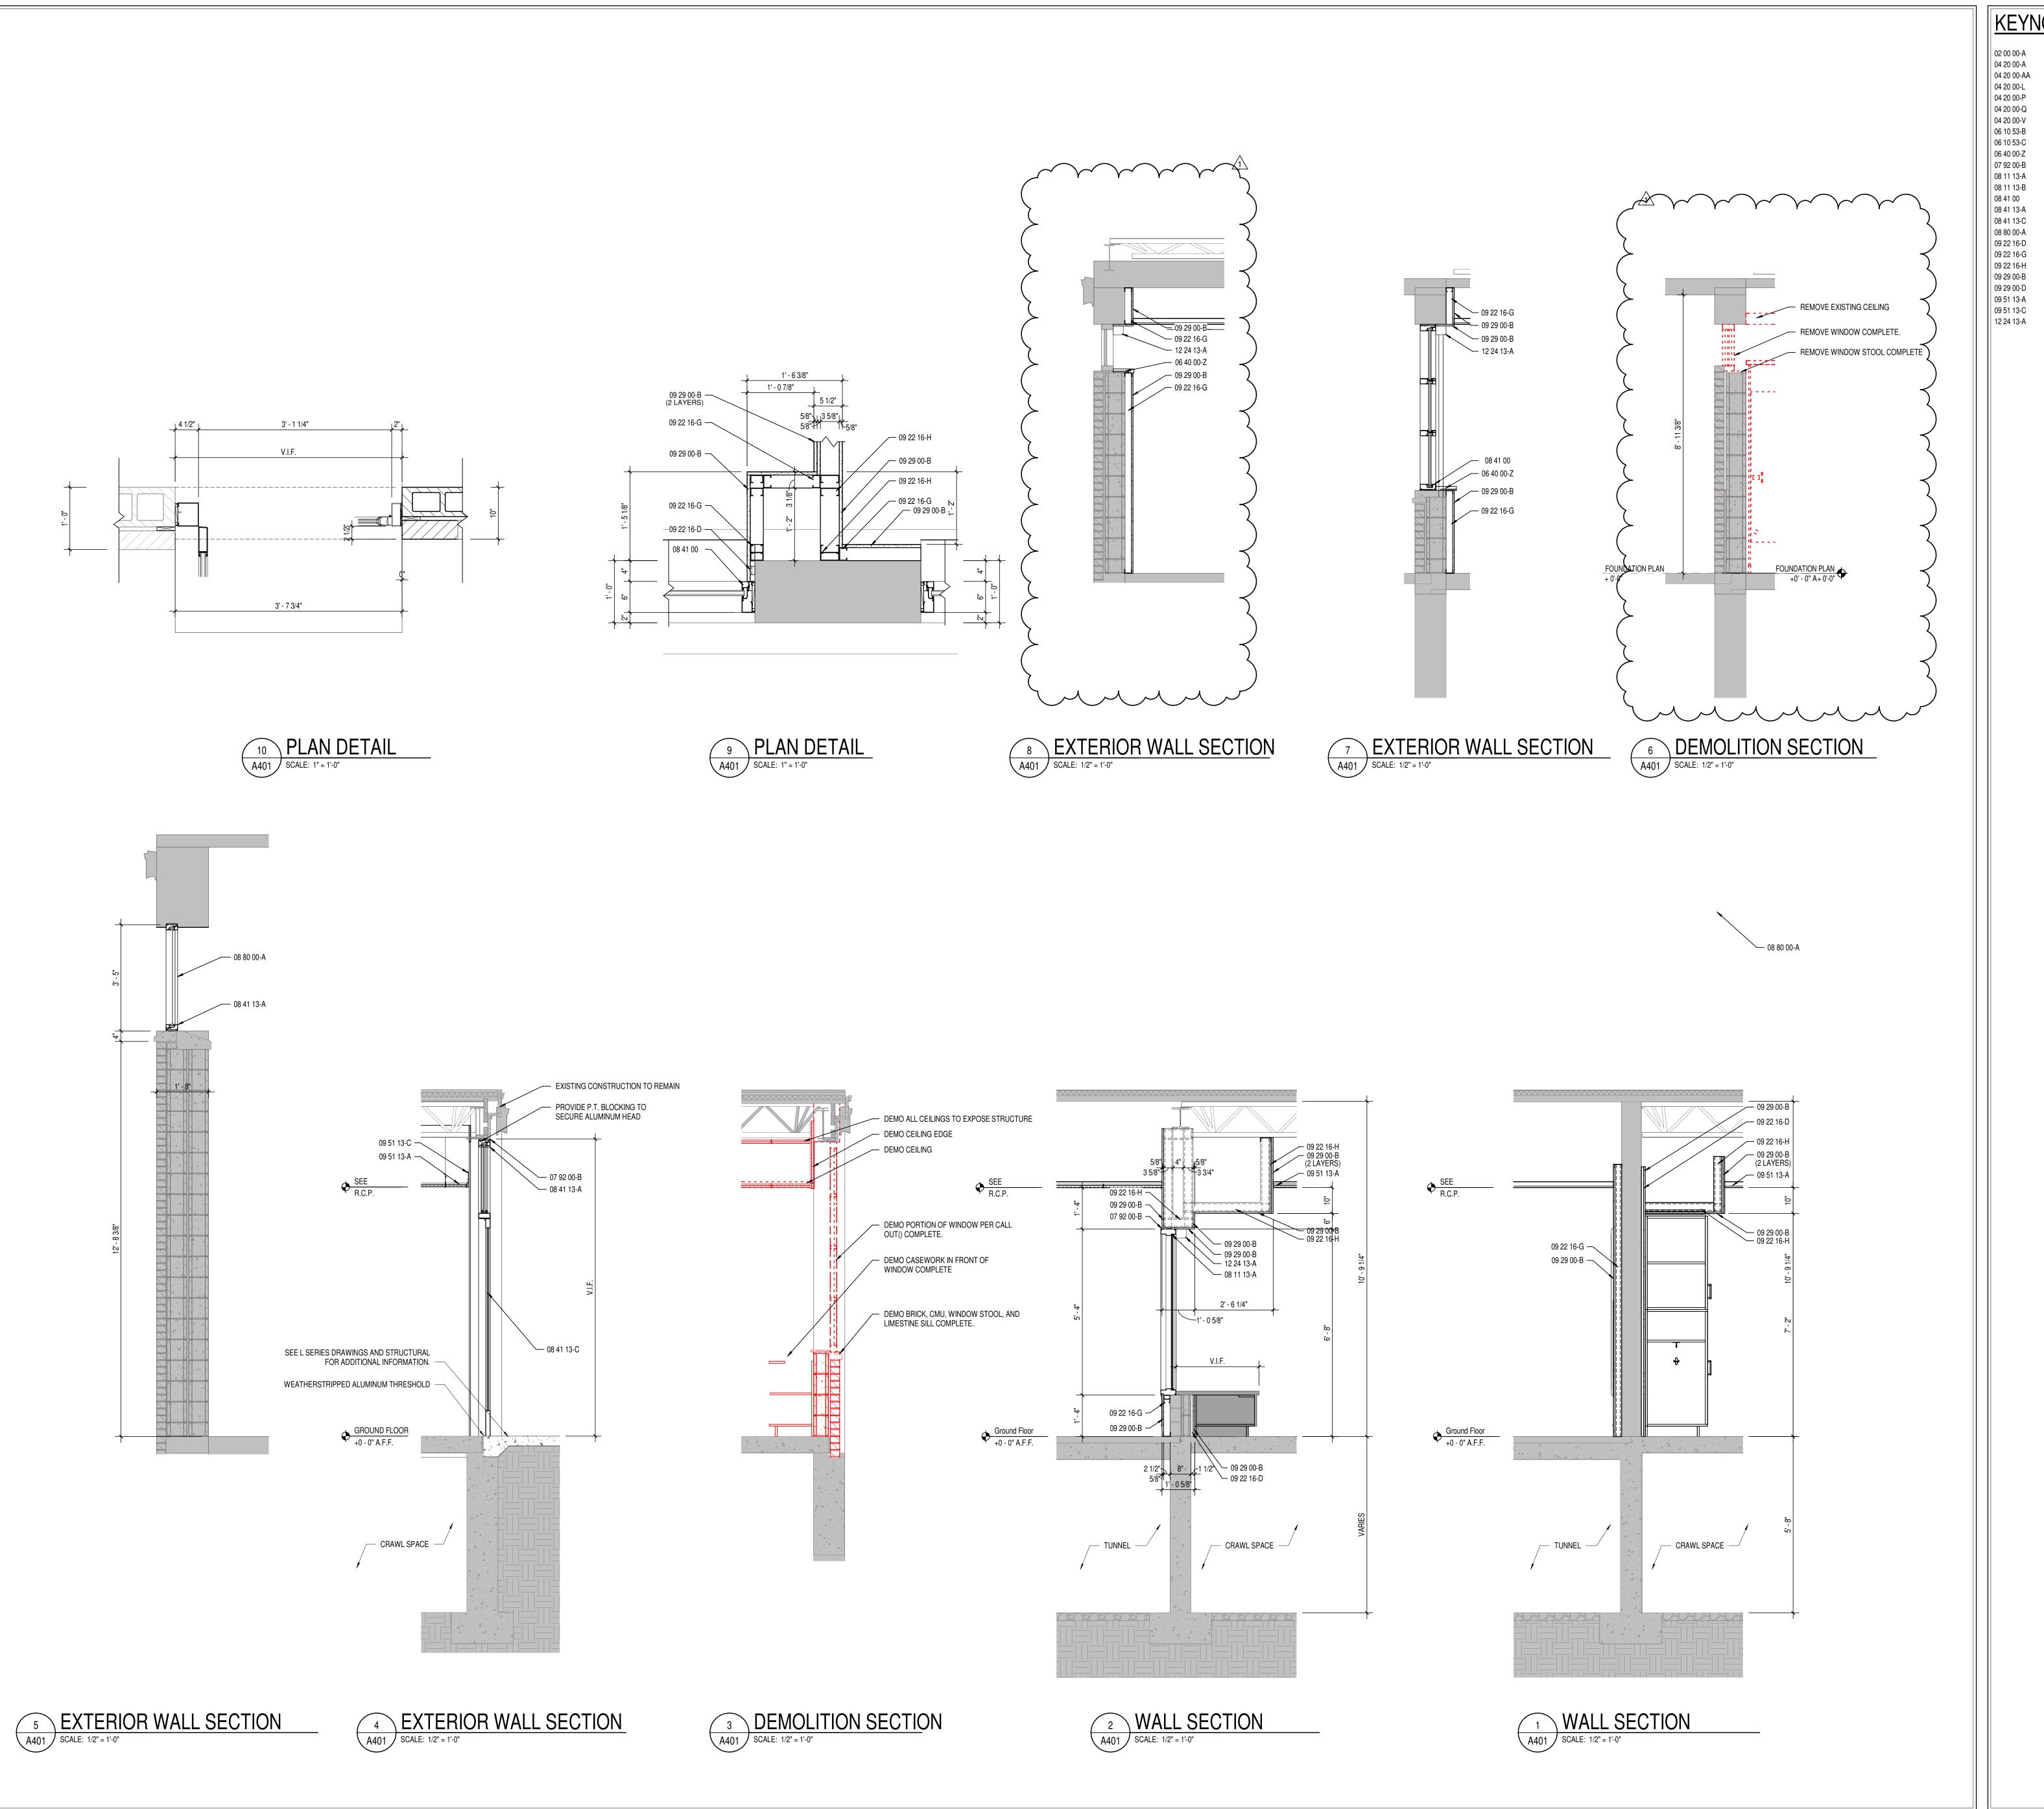

KEYNOTE LEGEND

EXISTING TO REMAIN 04 20 00-A GROUT CORE SOLID 04 20 00-AA BOND BEAM MASONRY LINTEL BRICK TYPE 1 6" CONCRETE MASONRY UNIT 8" CONCRETE MASONRY UNIT BOND BEAM MASONRY UNIT 1X WOOD BLOCKING

2X WOOD BLOCKING SOLID PLASTIC SURFACE - 1/2" WINDOW STOOL SEALANT EACH SIDE, TYPICAL

HOLLOW METAL DOOR/BORROWED LIGHT FRAME HOLLOW METAL DOOR 6" ALUMINUM-FRAMED STOREFRONT

4 1/2" ALUMINUM-FRAMED STOREFRONT ALUMINUM ENTRANCE DOOR GLAZING - SEE SCHEDULE/ELEVATIONS 7/8" FURRING CHANNEL

2 1/2" STEEL STUD 3 5/8" STEEL STUD 5/8" GYPSUM WALL BOARD (SEE SPECS FOR TYPE) SOUND ATTENUATION INSULATION

ACOUSTICAL CEILING SUSPENSION ASSEMBLY DECORATIVE ACOUSTICAL CEILING EDGE TRIM ROLLER WINDOW SHADES- SEE EQUIPMENT SCHEDULE WBCSC TOGETHER WE LEARN

O E CORPORA RENOVATIO RICHARD L. JOF 1209 S SYCAMORE ST, CC

SCOPE DRAWINGS:

These drawings indicate the general scope of the project in terms of architectural design concept, the dimensions of the building, the major architectural elements and the type of structural, mechanical and electrical systems.

The drawings do not necessarily indicate or describe all work required for full performance and completion of the requirements of the Contract.


On the basis of the general scope indicated or described, the trade contractors shall furnish all items required for the

REVISIONS: ADDENDUM #1 12-03-2024


ISSUE DATE | DRAWN BY | CHECKED BY

DRAWING TITLE: WALL SECTIONS & PLAN DETAILS

11/20/2024 JAG

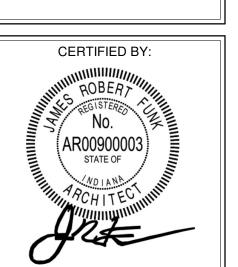

DRAWING NUMBER A401

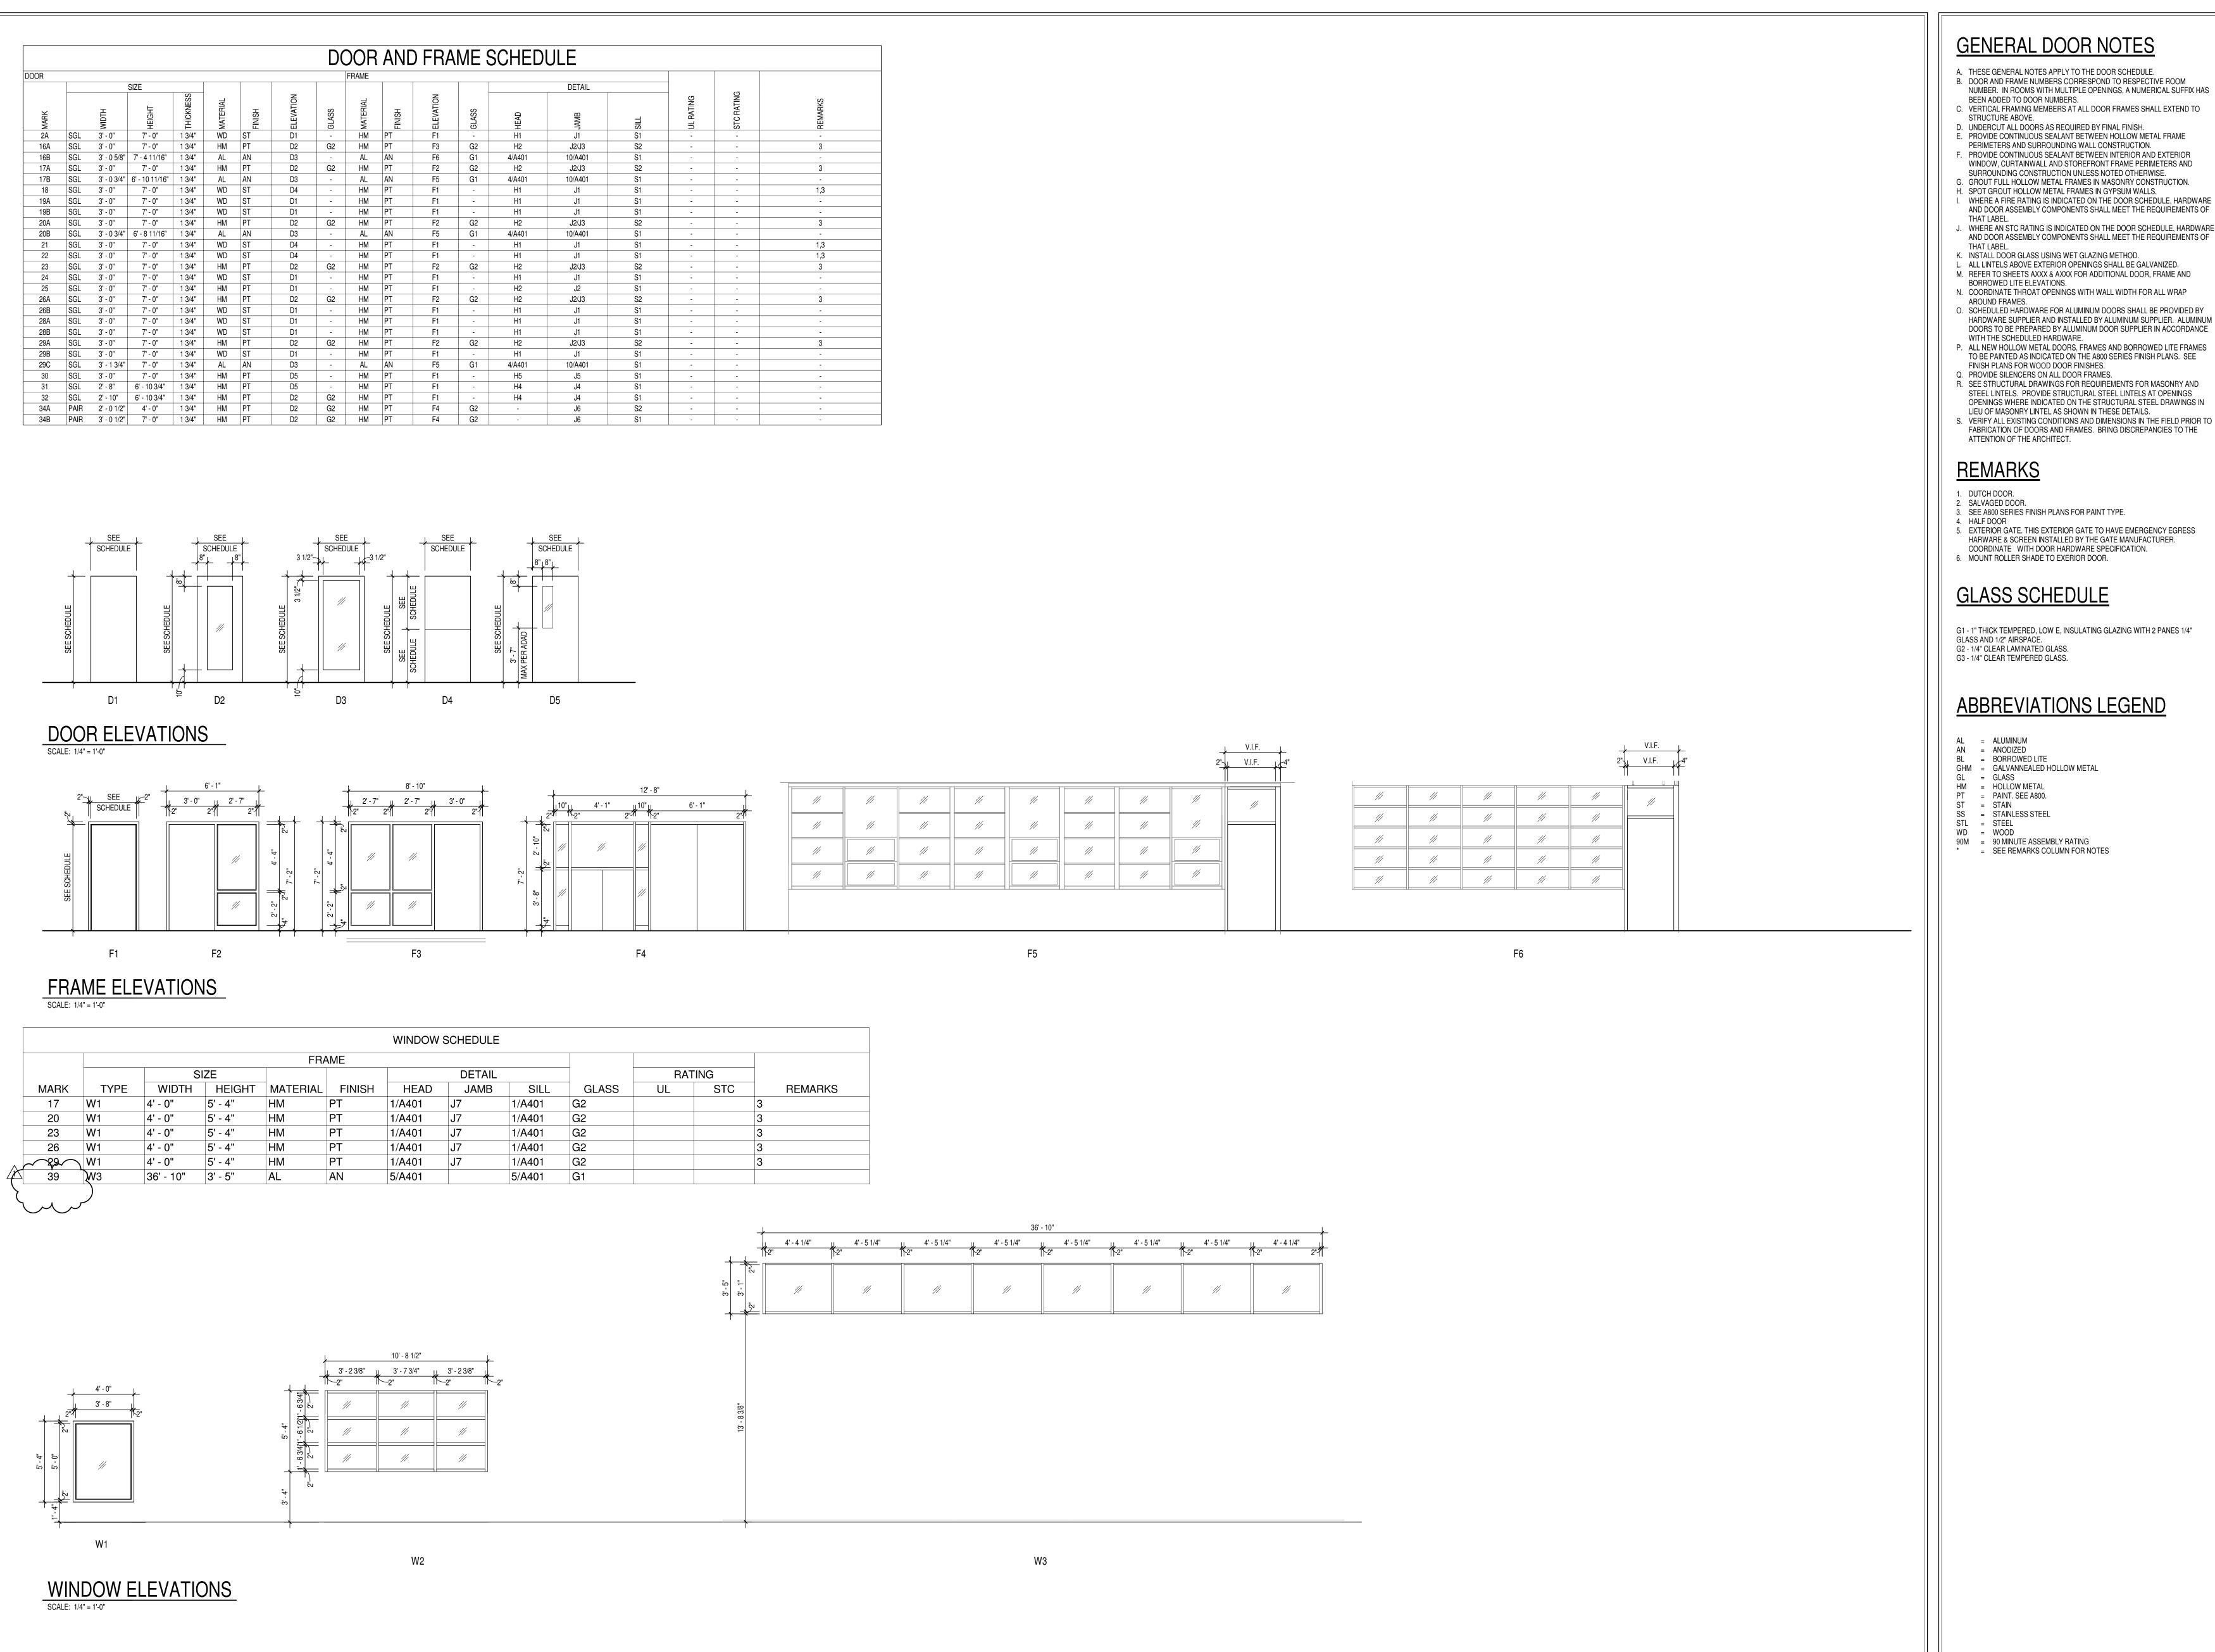

GENERAL DOOR NOTES

- A. THESE GENERAL NOTES APPLY TO THE DOOR SCHEDULE. B. DOOR AND FRAME NUMBERS CORRESPOND TO RESPECTIVE ROOM NUMBER. IN ROOMS WITH MULTIPLE OPENINGS, A NUMERICAL SUFFIX HAS
- BEEN ADDED TO DOOR NUMBERS. C. VERTICAL FRAMING MEMBERS AT ALL DOOR FRAMES SHALL EXTEND TO
- STRUCTURE ABOVE.
- D. UNDERCUT ALL DOORS AS REQUIRED BY FINAL FINISH. E. PROVIDE CONTINUOUS SEALANT BETWEEN HOLLOW METAL FRAME PERIMETERS AND SURROUNDING WALL CONSTRUCTION.
- F. PROVIDE CONTINUOUS SEALANT BETWEEN INTERIOR AND EXTERIOR WINDOW, CURTAINWALL AND STOREFRONT FRAME PERIMETERS AND
- SURROUNDING CONSTRUCTION UNLESS NOTED OTHERWISE. G. GROUT FULL HOLLOW METAL FRAMES IN MASONRY CONSTRUCTION.
- I. WHERE A FIRE RATING IS INDICATED ON THE DOOR SCHEDULE, HARDWARE AND DOOR ASSEMBLY COMPONENTS SHALL MEET THE REQUIREMENTS OF
- J. WHERE AN STC RATING IS INDICATED ON THE DOOR SCHEDULE, HARDWARE AND DOOR ASSEMBLY COMPONENTS SHALL MEET THE REQUIREMENTS OF
- K. INSTALL DOOR GLASS USING WET GLAZING METHOD. L. ALL LINTELS ABOVE EXTERIOR OPENINGS SHALL BE GALVANIZED.
- M. REFER TO SHEETS AXXX & AXXX FOR ADDITIONAL DOOR, FRAME AND BORROWED LITE ELEVATIONS.
- AROUND FRAMES. O. SCHEDULED HARDWARE FOR ALUMINUM DOORS SHALL BE PROVIDED BY HARDWARE SUPPLIER AND INSTALLED BY ALUMINUM SUPPLIER. ALUMINUM
- WITH THE SCHEDULED HARDWARE. P. ALL NEW HOLLOW METAL DOORS, FRAMES AND BORROWED LITE FRAMES TO BE PAINTED AS INDICATED ON THE A800 SERIES FINISH PLANS. SEE
- FINISH PLANS FOR WOOD DOOR FINISHES.
- Q. PROVIDE SILENCERS ON ALL DOOR FRAMES. R. SEE STRUCTURAL DRAWINGS FOR REQUIREMENTS FOR MASONRY AND STEEL LINTELS. PROVIDE STRUCTURAL STEEL LINTELS AT OPENINGS
- S. VERIFY ALL EXISTING CONDITIONS AND DIMENSIONS IN THE FIELD PRIOR TO FABRICATION OF DOORS AND FRAMES. BRING DISCREPANCIES TO THE ATTENTION OF THE ARCHITECT.

REMARKS

- 1. DUTCH DOOR.
- 3. SEE A800 SERIES FINISH PLANS FOR PAINT TYPE.
- 5. EXTERIOR GATE. THIS EXTERIOR GATE TO HAVE EMERGENCY EGRESS HARWARE & SCREEN INSTALLED BY THE GATE MANUFACTURER.
- COORDINATE WITH DOOR HARDWARE SPECIFICATION. 6. MOUNT ROLLER SHADE TO EXERIOR DOOR.

GLASS SCHEDULE

G1 - 1" THICK TEMPERED, LOW E, INSULATING GLAZING WITH 2 PANES 1/4" GLASS AND 1/2" AIRSPACE. G2 - 1/4" CLEAR LAMINATED GLASS. G3 - 1/4" CLEAR TEMPERED GLASS.

ABBREVIATIONS LEGEND

- AL = ALUMINUM AN = ANODIZED
- GHM = GALVANNEALED HOLLOW METAL

- SS = STAINLESS STEEL
- 90M = 90 MINUTE ASSEMBLY RATING * = SEE REMARKS COLUMN FOR NOTES



OE BARTHOLOMEW COUNTY SCHOOL CORPORATION
RENOVATIONS TO
AICHARD L. JOHNSON EEC

SCOPE DRAWINGS: These drawings indicate the general scope of the project in terms of architectural design concept, the dimensions of the building, the major architectural elements and the type of structural, mechanical and electrical systems.


The drawings do not necessarily indicate or describe all work required for full performance and completion of the requirements of the Contract.

On the basis of the general scope indicated or described, the trade contractors shall furnish all items required for the the trade contractors shall furnish all items required for the proper execution and completion of the work.


> REVISIONS: ADDENDUM #1 12-03-2024

ISSUE DATE | DRAWN BY | CHECKED BY 11/20/2024 JAG ECN

> DRAWING TITLE: WINDOW SCHEDULE

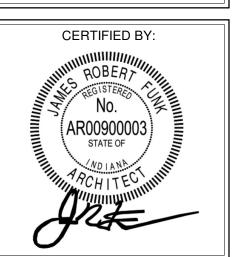

DRAWING NUMBER A501

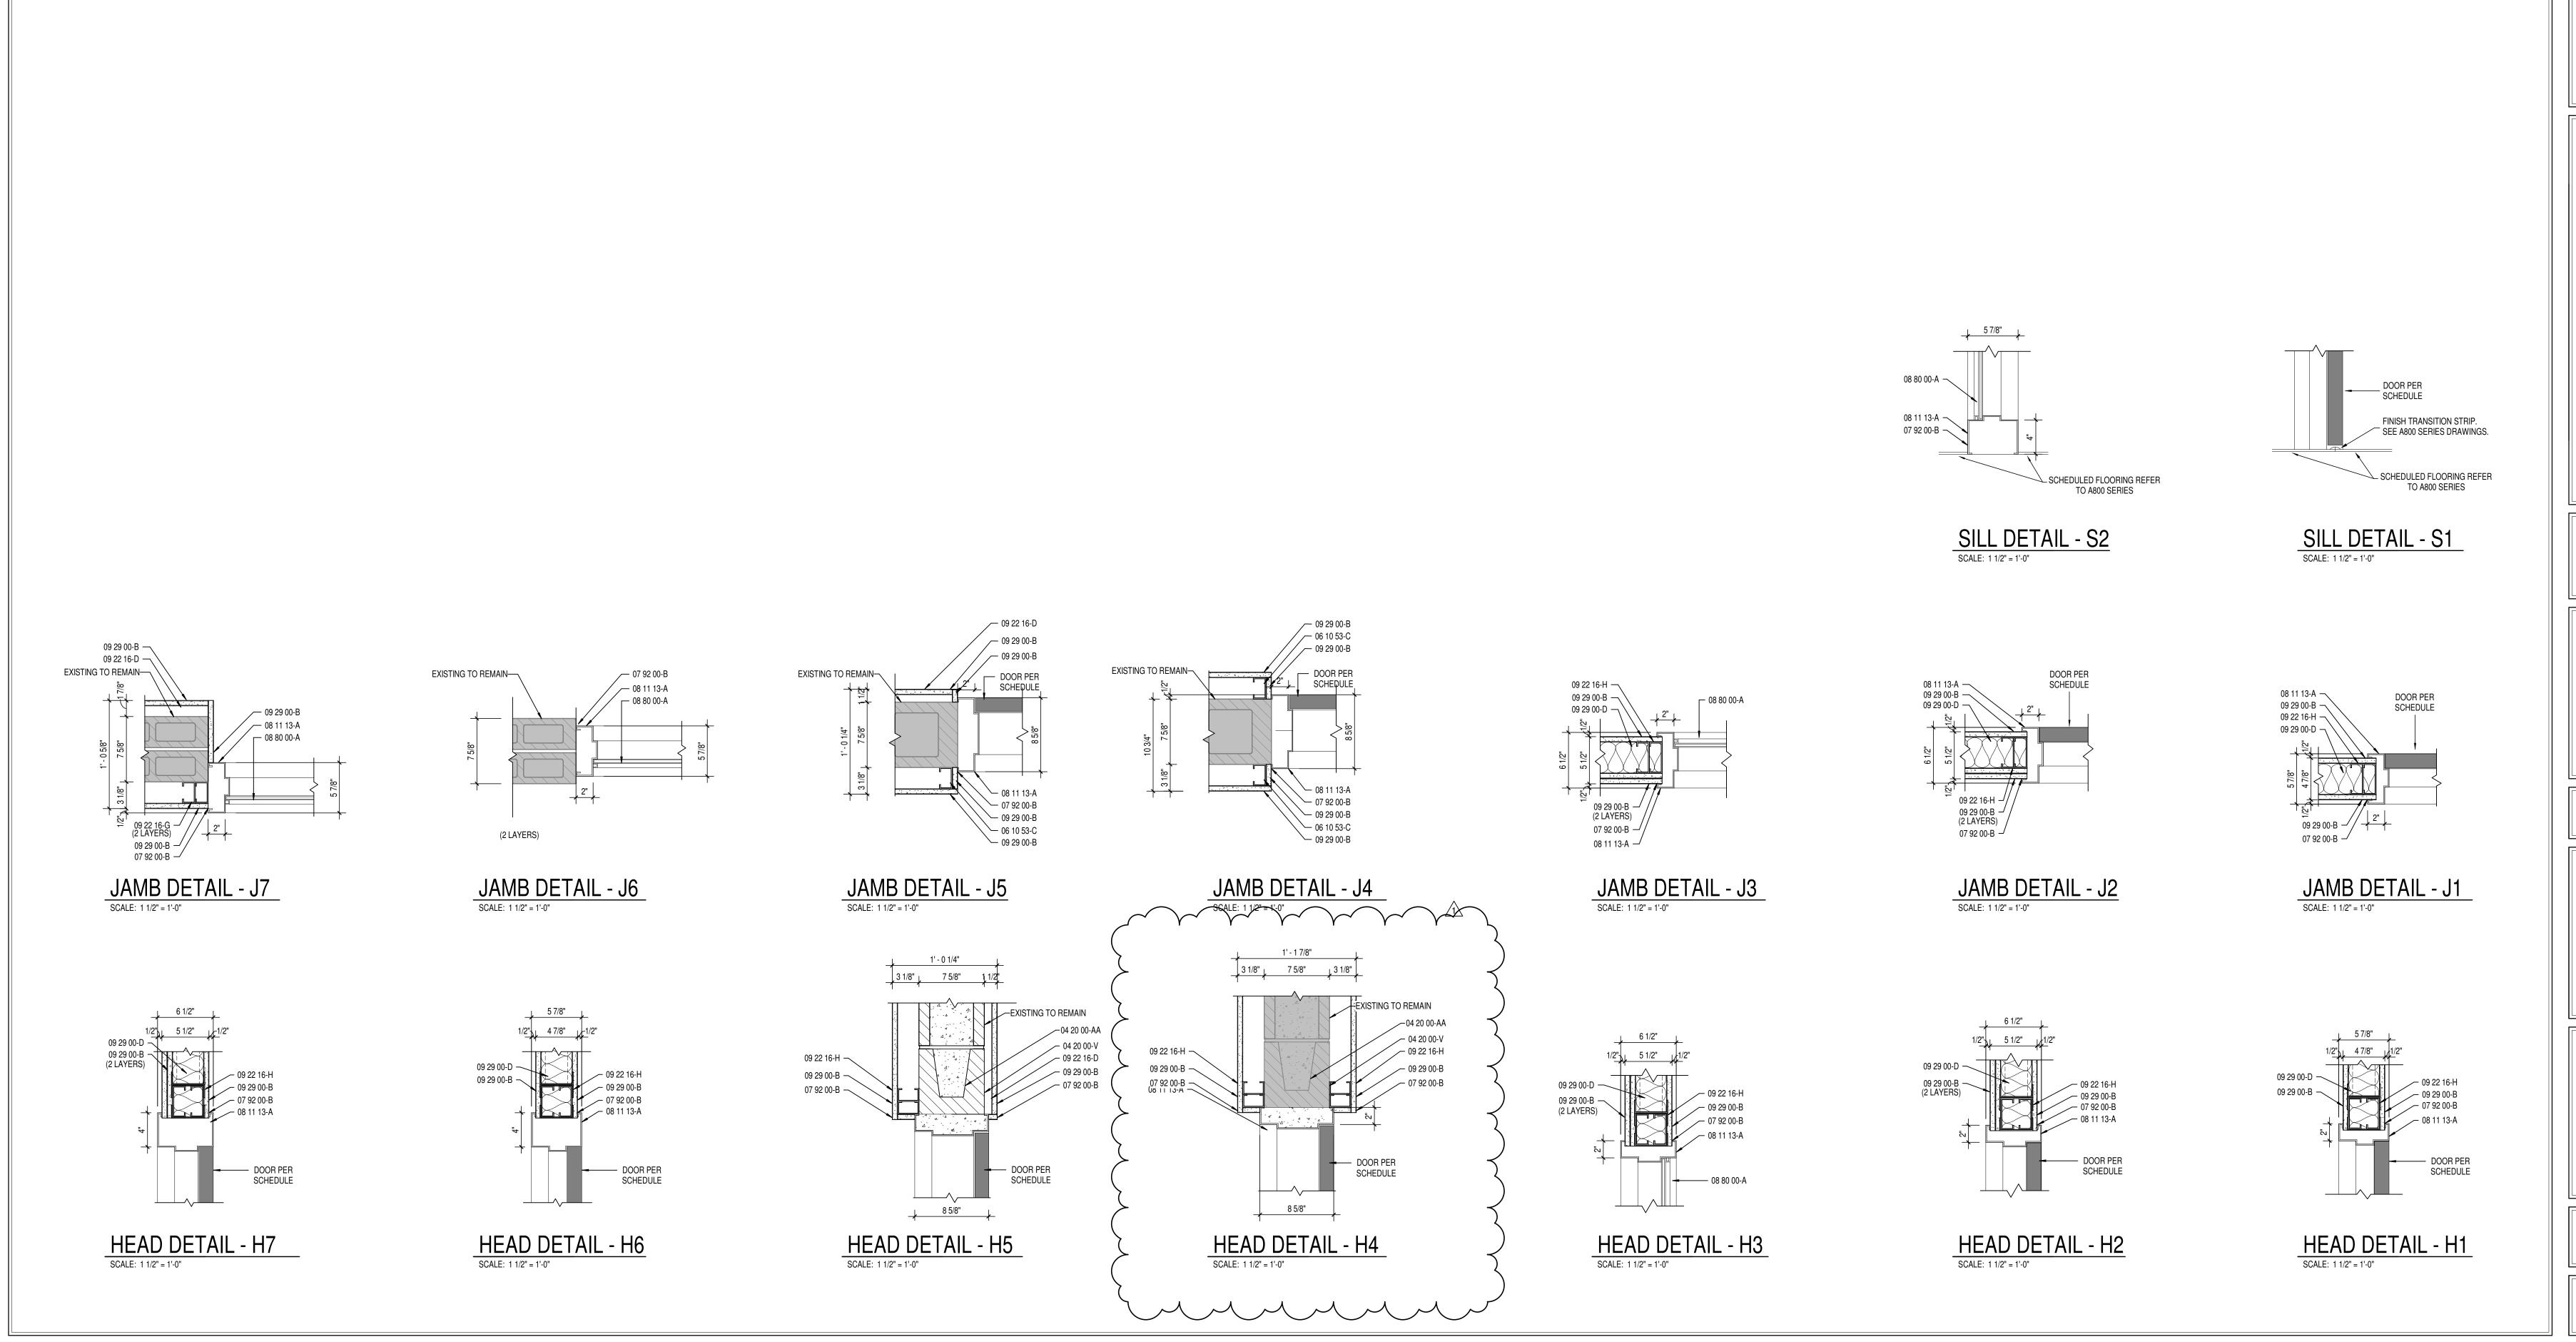



8831 Keystone Crossing, Indianapolis, IN 46240

BARTHOLOMEW COUNTY SCHOOL
CORPORATION
RENOVATIONS TO
RICHARD L. JOHNSON EEC
1209 S SYCAMORE ST, COLUMBUS, IN 47201

SCOPE DRAWINGS:

These drawings indicate the general scope of the project in terms of architectural design concept, the dimensions of the building, the major architectural elements and the type of structural, mechanical and electrical systems.

The drawings do not necessarily indicate or describe all work required for full performance and completion of the requirements of the Contract.

On the basis of the general scope indicated or described, the trade contractors shall furnish all items required for the proper execution and completion of the work.


REVISIONS: ADDENDUM #1 12-03-2024

ISSUE DATE DRAWN BY CHECKED BY


11/20/2024 JAG ECN

DRAWING TITLE:
HEAD, JAMB,

IEAD, JAMB, AND SILL DETAILS

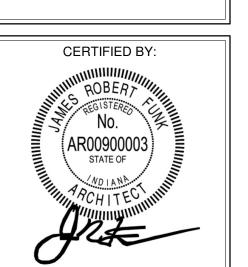

A502

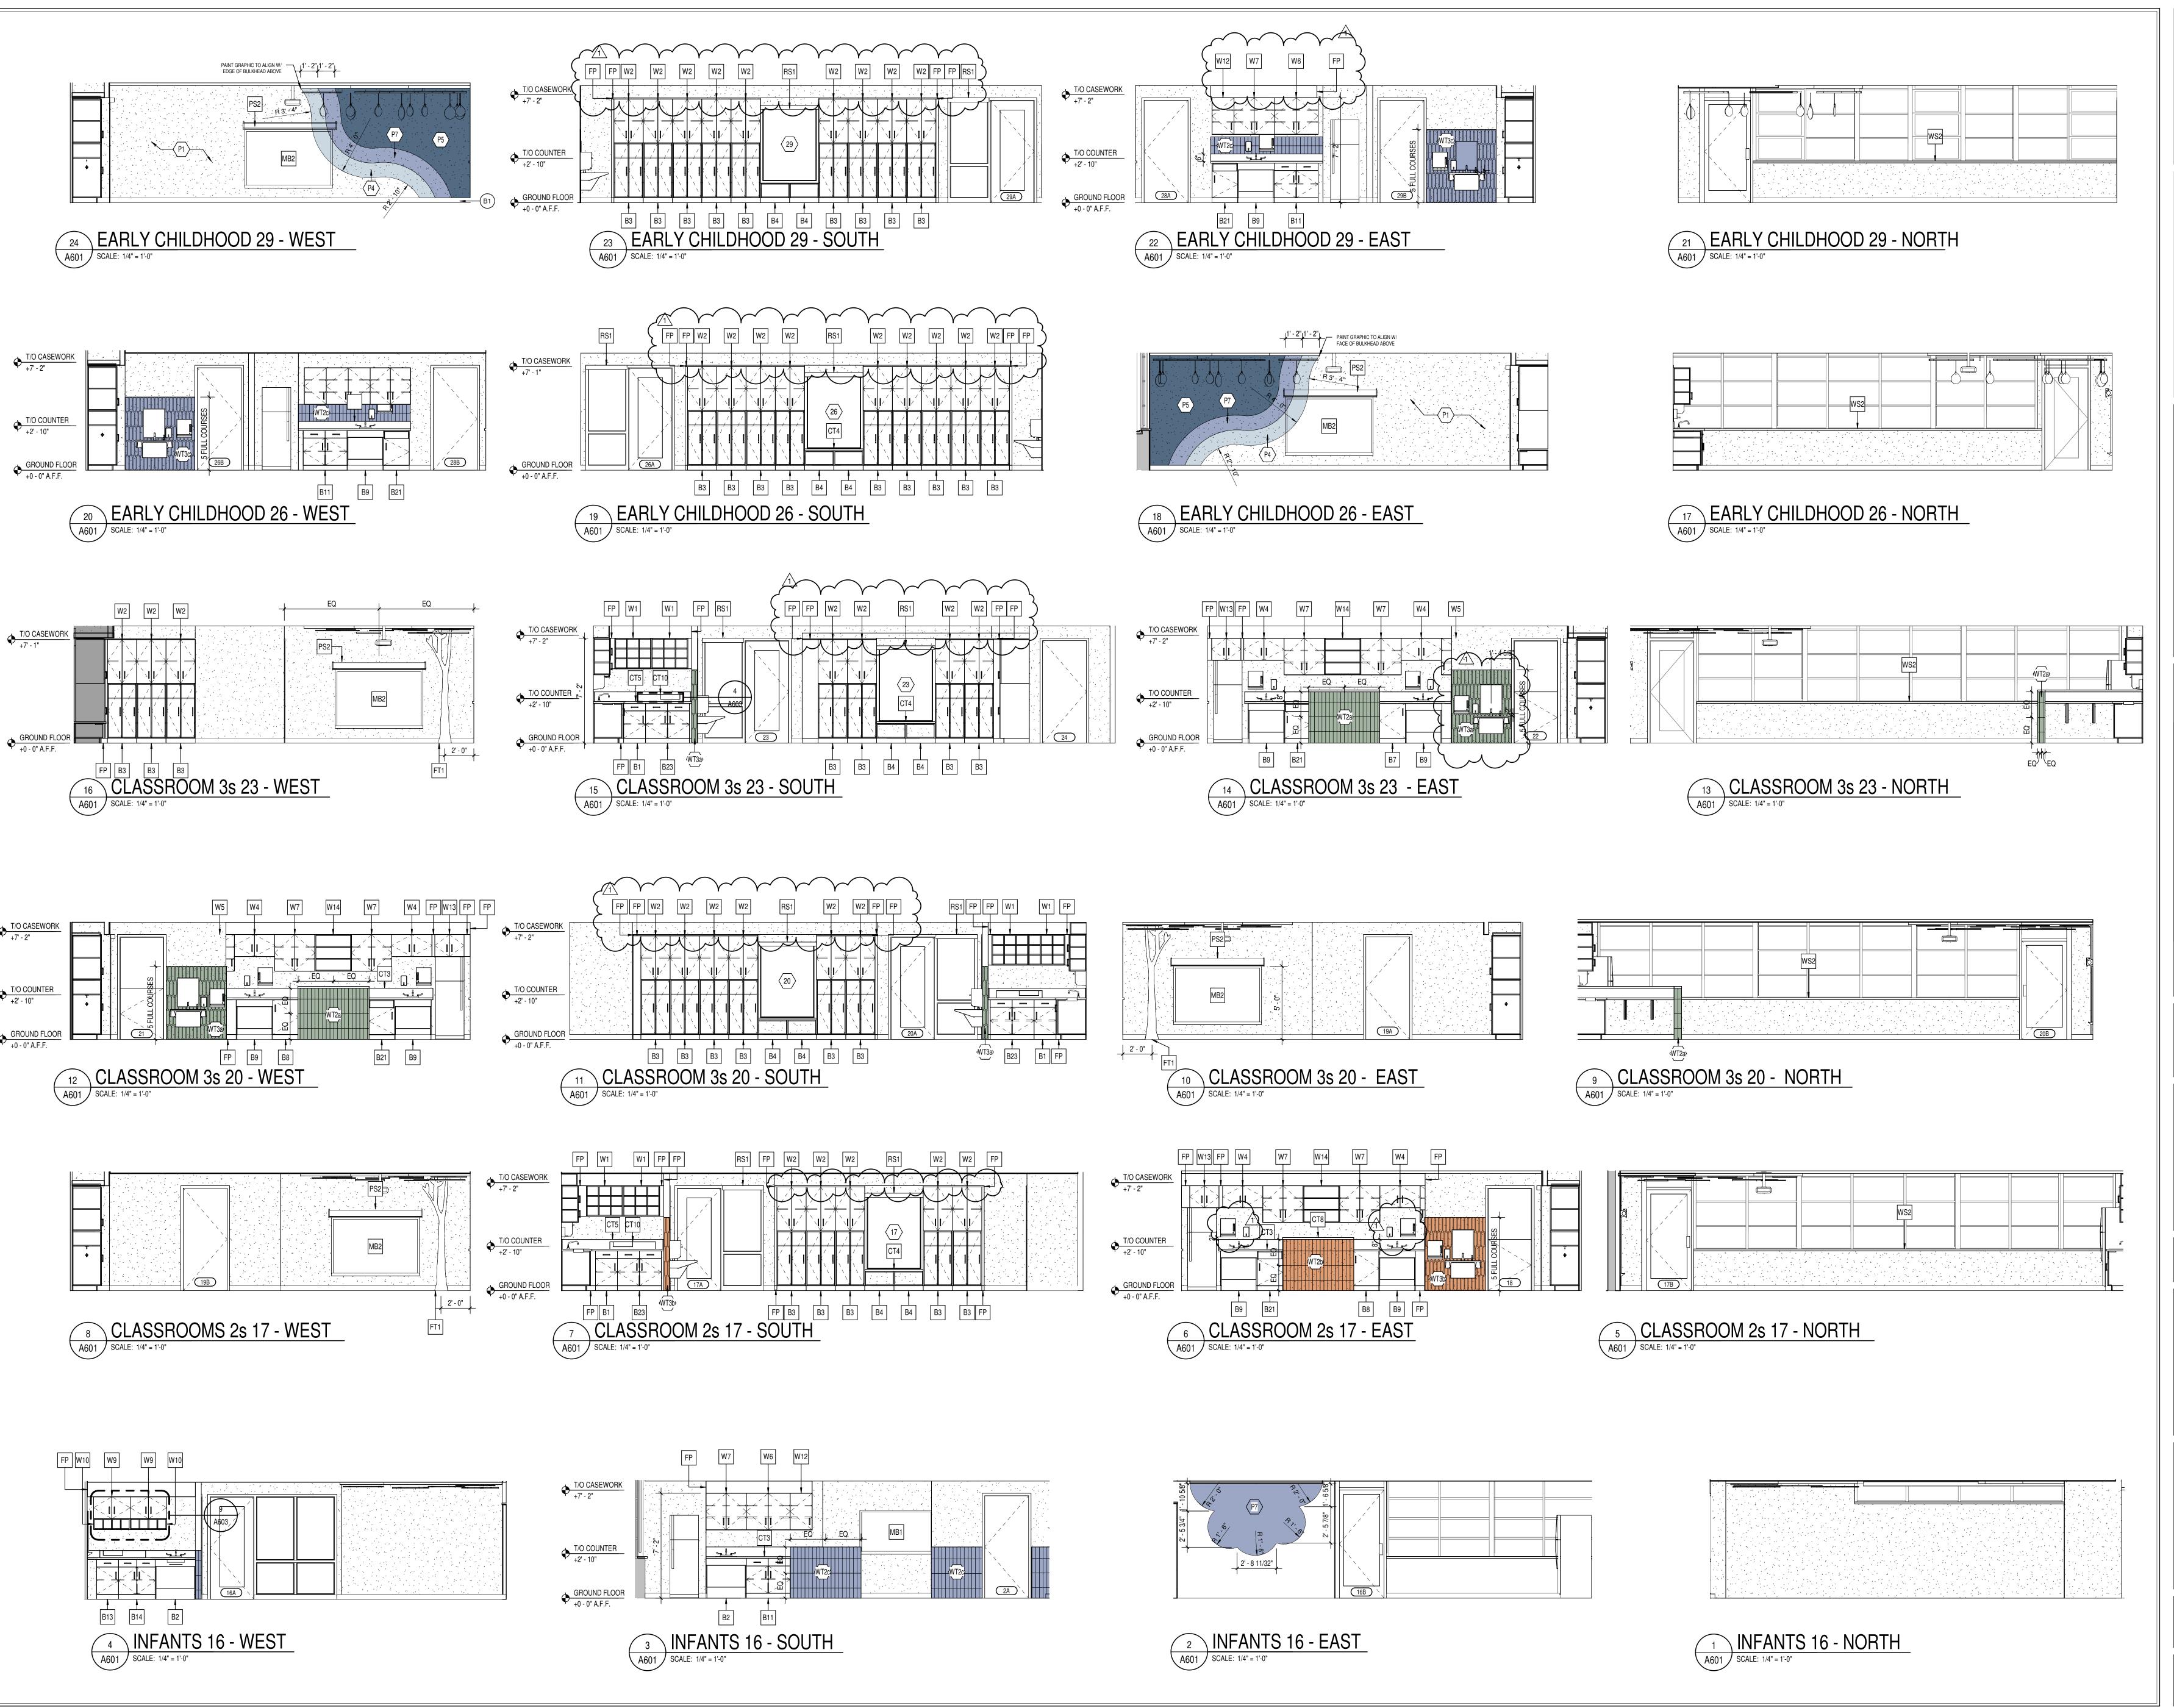



S831 Keystone Crossing, Indianapolis, IN 46240

BARTHOLOMEW COUNTY SCHOOL
CORPORATION
RENOVATIONS TO
AICHARD L. JOHNSON EEC

SCOPE DRAWINGS:

These drawings indicate the general scope of the project in terms of architectural design concept, the dimensions of the building, the major architectural elements and the type of structural, mechanical and electrical systems.

The drawings do not necessarily indicate or describe all work required for full performance and completion of the equirements of the Contract.


On the basis of the general scope indicated or described, the trade contractors shall furnish all items required for the proper execution and completion of the work.

REVISIONS:


ADDENDUM #1 12-03-2024

ISSUE DATE DRAWN BY CHECKED BY
11/20/2024 RNR ECN


INTERIOR
ELEVATIONS

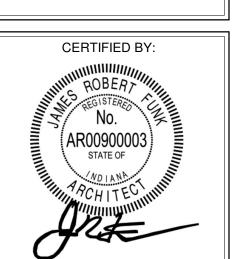

	10	ILET ACCESS		IILDULL
TYPE MARK	ITEM DESCRIPTION	MANUFACTURER	MODEL#	MOUNTING HEIGHT
FT1	FIXED TREE	TMC FURNITURE	GROVE TREE	04 OF WAY, OF WALL TRANSPARENT MADEE WOOD MILK FINISH
				21.25"W x 95"H. TRANSPARENT MAPLE WOOD, MILK FINISH.
T1	TOILET TISSUE DISPENSER - SURFACE MOUNTED	ASI	0715	
T2	SOAP DISPENSER - SURFACE MOUNTED	BY OWNER	-	-
T3	PAPER TOWEL DISPENSER - SURFACE MOUNTED	BY OWNER	-	•
T4	GRAB BAR - 36"	BOBRICK	B-5806	MOUNT @ 34" ADA HEIGHT
T5	GRAB BAR - 42"	BOBRICK	B-5806	MOUNT @ 34" ADA HEIGHT
T6	GRAB BAR - 18"	BOBRICK	B-5806	BOTTOM @ 40" A.F.F. INSTALLED VERTICALLY
T7	SANITARY NAPKIN DISPOSAL - SURFACE MOUNTED	BOBRICK	B-254	MOUNT AS REQUIRED FOR ADA. COORDINATE LOCATION WITH GRAB BARS
T8	GLASS MIRROR - STAINLESS STEEL ANGLE FRAME 18" W x 36"H	SEE SPEC #10 28 00	SEE SPEC	MOUNT AS REQUIRED FOR ADA.
Т9	GLASS MIRROR - STAINLESS STEEL ANGLE FRAME 18" W x 24"H	BOBRICK	B-165	MOUNT AS REQUIRED FOR ADA.
T10	CHILDREN'S HEIGHT GRAB BAR - 36"	BOBRICK	B-5806	MOUNT @ 20" CHILDREN'S ADA HEIGHT
T11	CHILDREN'S HEIGHT GRAB BAR - 42"	BOBRICK	B-5806	MOUNT @ 20" CHILDREN'S ADA HEIGHT
T12	CHILDREN'S HEIGHT GRAB BAR - 18"	BOBRICK	B-5806	BOTTOM @ 23" A.F.F. INSTALLED VERTICALLY
T13	BABY CHANGING STATION - WALL MOUNTED			
T14	TOILET PARTITION	SEE SPEC #10 21 13	-	-
T15	TRASH RECEPTACLE	DENNIS BUILDING&JOINERY	B09W92CWTH	

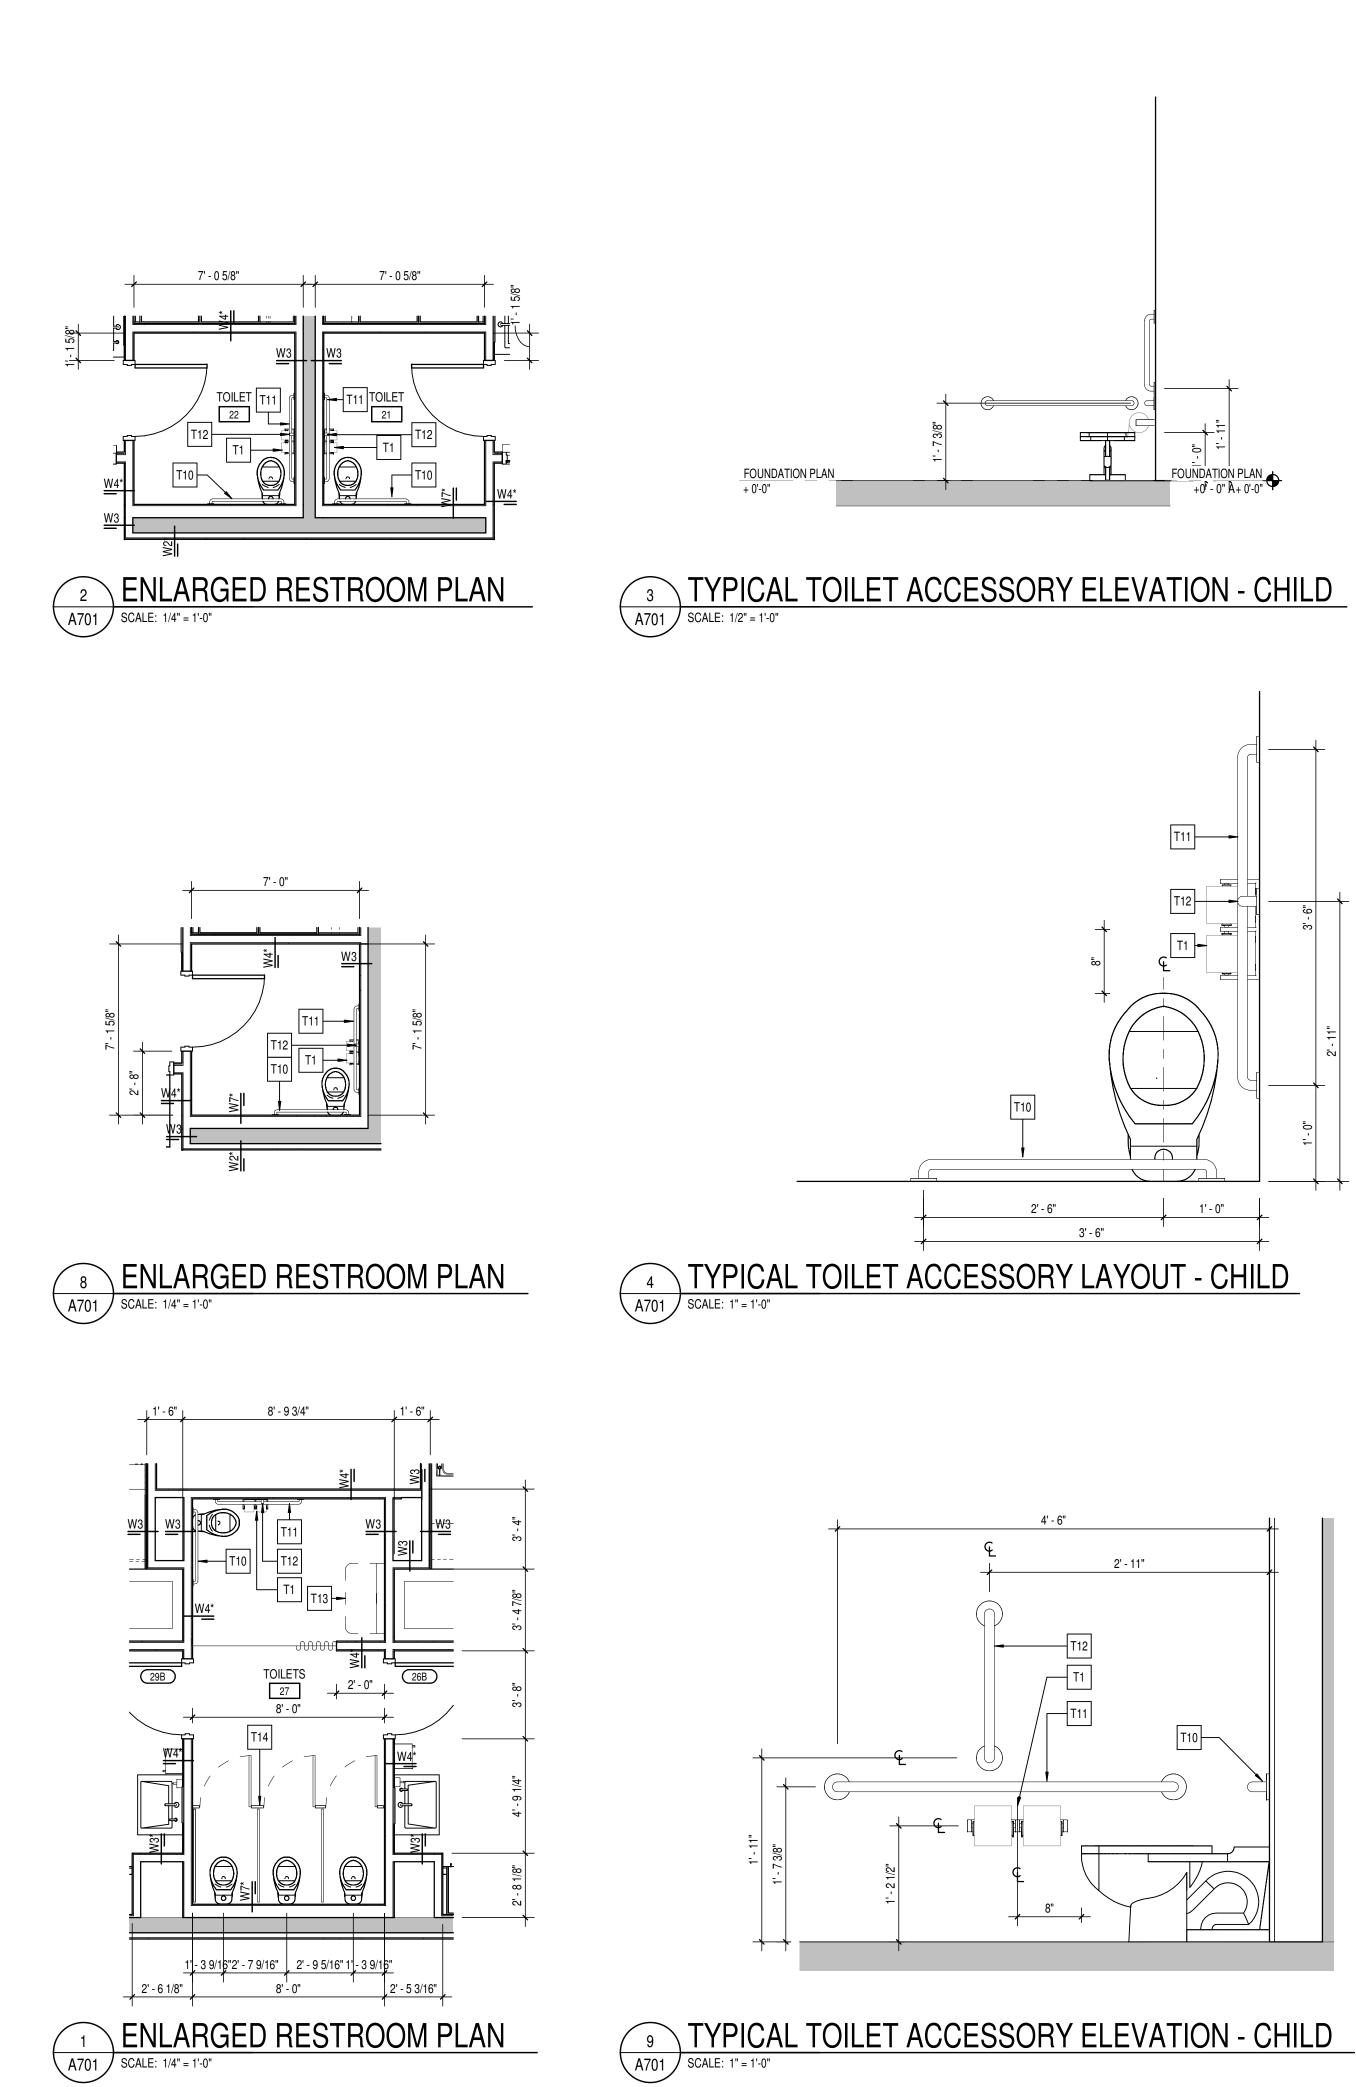

9 TYPICAL TOILET ACCESSORY ELEVATION - CHILD
SCALE: 1" = 1'-0"

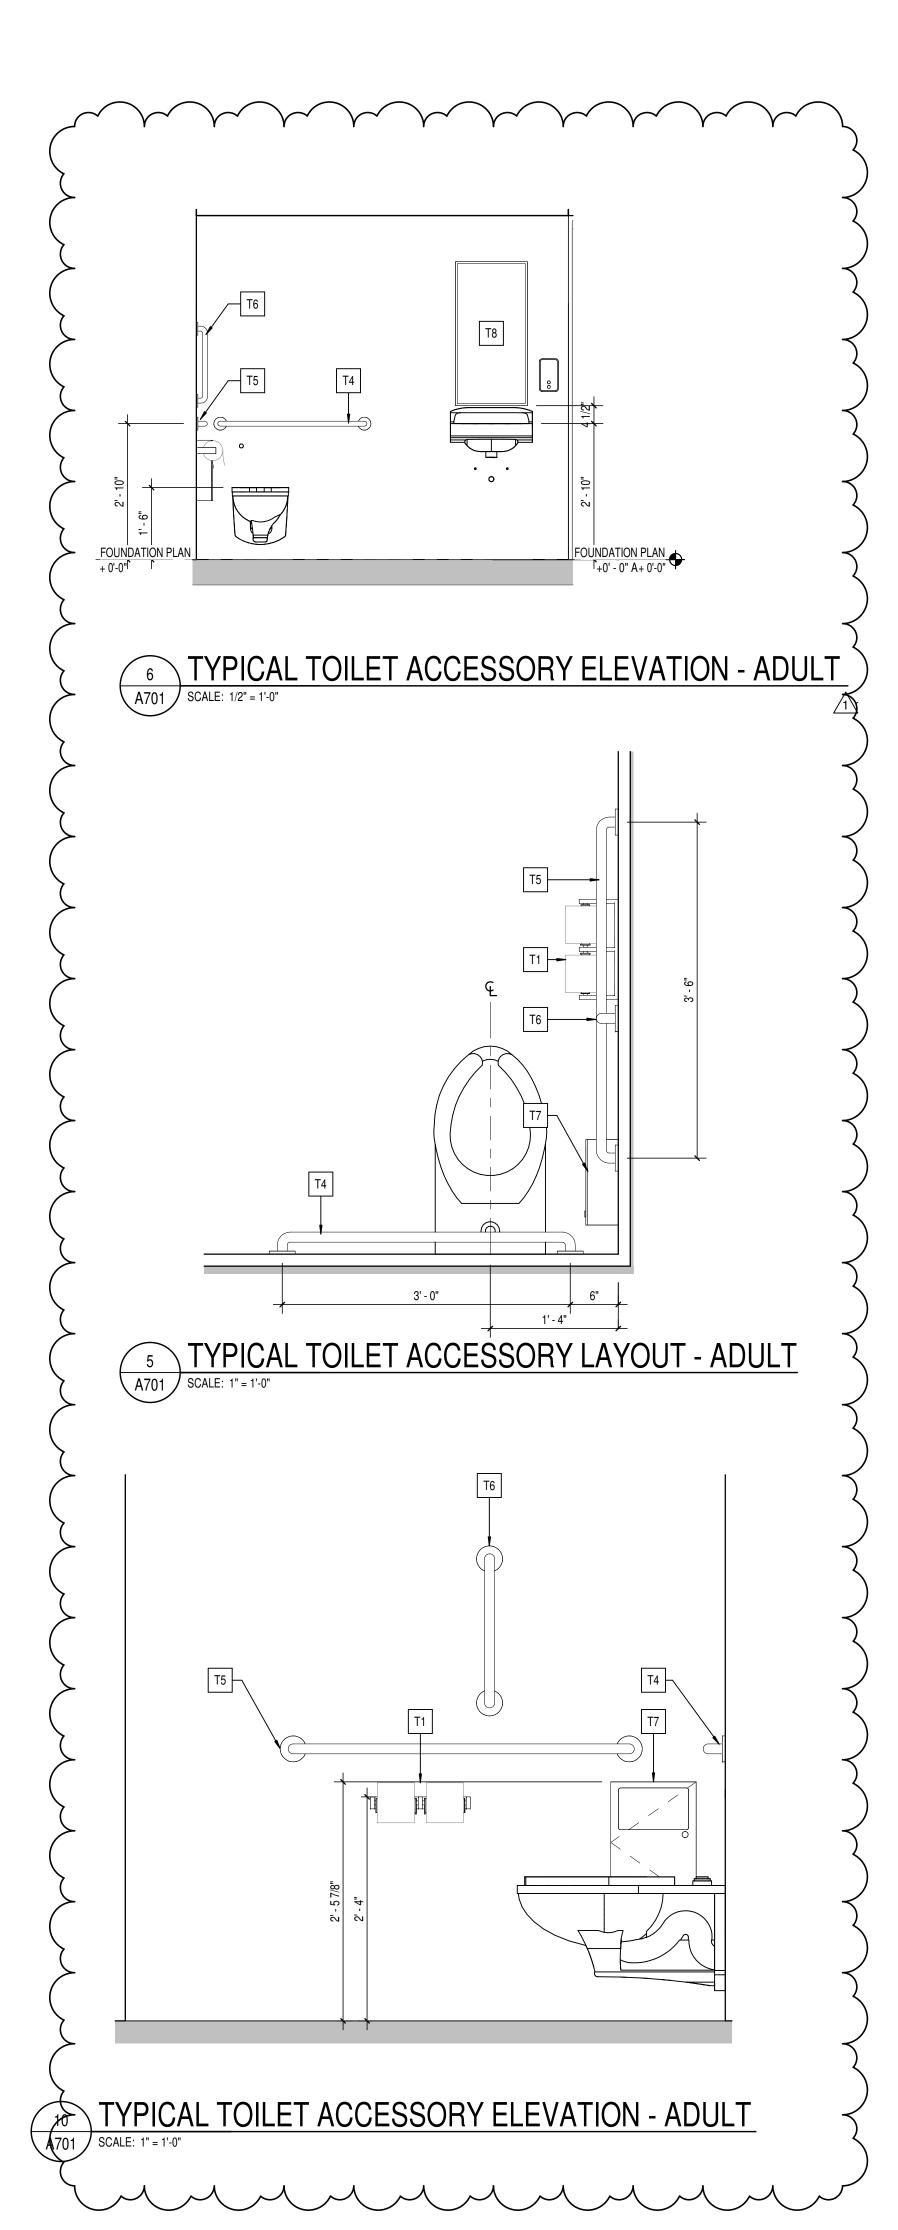



BARTHOLOMEW COUNTY SCHOOL
CORPORATION
RENOVATIONS TO
AICHARD L. JOHNSON EEC
1209 S SYCAMORE ST, COLUMBUS, IN 47201

SCOPE DRAWINGS:

These drawings indicate the general scope of the project in terms of architectural design concept, the dimensions of the building, the major architectural elements and the type of structural, mechanical and electrical systems.


The drawings do not necessarily indicate or describe all work required for full performance and completion of the requirements of the Contract.

On the basis of the general scope indicated or described, the trade contractors shall furnish all items required for the proper execution and completion of the work.

REVISIONS: ADDENDUM #1 12-03-2024


ISSUE DATE | DRAWN BY | CHECKED BY 11/20/2024

> DRAWING TITLE: **ENLARGED** RESTROOM **PLANS**

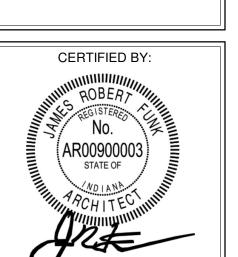

DRAWING NUMBER A701

	SPECIALTY EQUIPMENT SCHEDULE								
YPE MARK	DESCRIPTION	SPEC SECTION	MANUFACTURER	MODEL NO.	REMARKS	FURNISHED BY	INSTALLED BY		
AP1	REFRIGERATOR		INSIGNIA	NS-RBM11SS2	W/OPTIONAL ICE MAKER	CONTRACTOR	CONTRACTOR		
C1	CURTAIN								
FT1	FIXED TREE	06 40 00	TMC FURNITURE	GROVE TREE	21.25"W x 95"H. TRANSPARENT MAPLE WOOD, MILK FINISH.	CONTRACTOR	CONTRACTOR		
MB1	5'-0"W x 3'-0"H MARKER BOARD	10 11 00	CLARIDGE	SERIES 1	MOUNT TOP @ +(7'-0")	CONTRACTOR	CONTRACTOR		
MB2	6'-0"W x 4'-0"H MARKER BOARD	10 11 00	CLARIDGE	SERIES 1	MOUNT TOP @ +(5'-2")	CONTRACTOR	CONTRACTOR		
PS1	CEILING MOUNTED PROJECTOR	-	-	-	-	OWNER	CONTRACTOR		
PS2	PROJECTION SCREEN	11 52 13	DRAPER INC.	-	-	OWNER	CONTRACTOR		
RS1	MANUALLY OPERATED SINGLE ROLLER SHADE - BLACKOUT	12 24 13	DRAPER INC.	-	ROLLER SHADE TO BE FULL WIDTH OF WINDOW. PROVIDE ROLLER SHADE ON CLASSROOM DOORS & WINDOWS WHERE INDICATED.	CONTRACTOR	CONTRACTOR		
RS2	MANUALLY OPERATED SINGLE ROLLER SHADE - BLACKOUT & LIGHT FILTERING	12 24 13	DRAPER INC.	-	ROLLER SHADE TO BE FULL WIDTH OF WINDOW. PROVIDE ROLLER SHADE ON WINDOWS WHERE INDICATED. SEE SPEC FOR "STOP" LOCATION. ADD STOP IN SHADE TO ALIGHT WITH CEILING AT MULLION.	CONTRACTOR	CONTRACTOR		
T2	SOAP DISPENSER - SURFACE MOUNTED		BY OWNER	-	-	OWNER	CONTRACTOR		
T3	PAPER TOWEL DISPENSER - SURFACE MOUNTED		BY OWNER	-	-	OWNER	CONTRACTOR		
T15	TRASH RECEPTACLE		DENNIS BUILDING&JOINERY	B09W92CWTH		CONTRACTOR	CONTRACTOR		
TB1	2'-0"W x 5'-4"H FIXED TACK BOARD	10 11 00	CLARIDGE	SEE SPECS	MOUNT TOP @ +(6'-8"); CUSTOM 2" WIDE PERIMETER TRIM. SEE A602 FOR FRAME COLORS.	CONTRACTOR	CONTRACTOR		
TB2	4'-0"W x 5'-4"H FIXED TACK BOARD	10 11 00	CLARIDGE	SEE SPECS	MOUNT TOP @ +(6'-8"); CUSTOM 2" WIDE PERIMETER TRIM. SEE A602 FOR FRAME COLORS.	CONTRACTOR	CONTRACTOR		
W2	SALVAGED FRONT LOAD ELECTRIC DRYER		GE	GFD43OSSMWW	Item # 02681182000				
WM1	4.5 CU. FT. FRONT LOAD WASHER AND 7.4 CU. FT. DRY	ER	LG	WKE100H_A/WKG101H_A	Item # 02641162000				

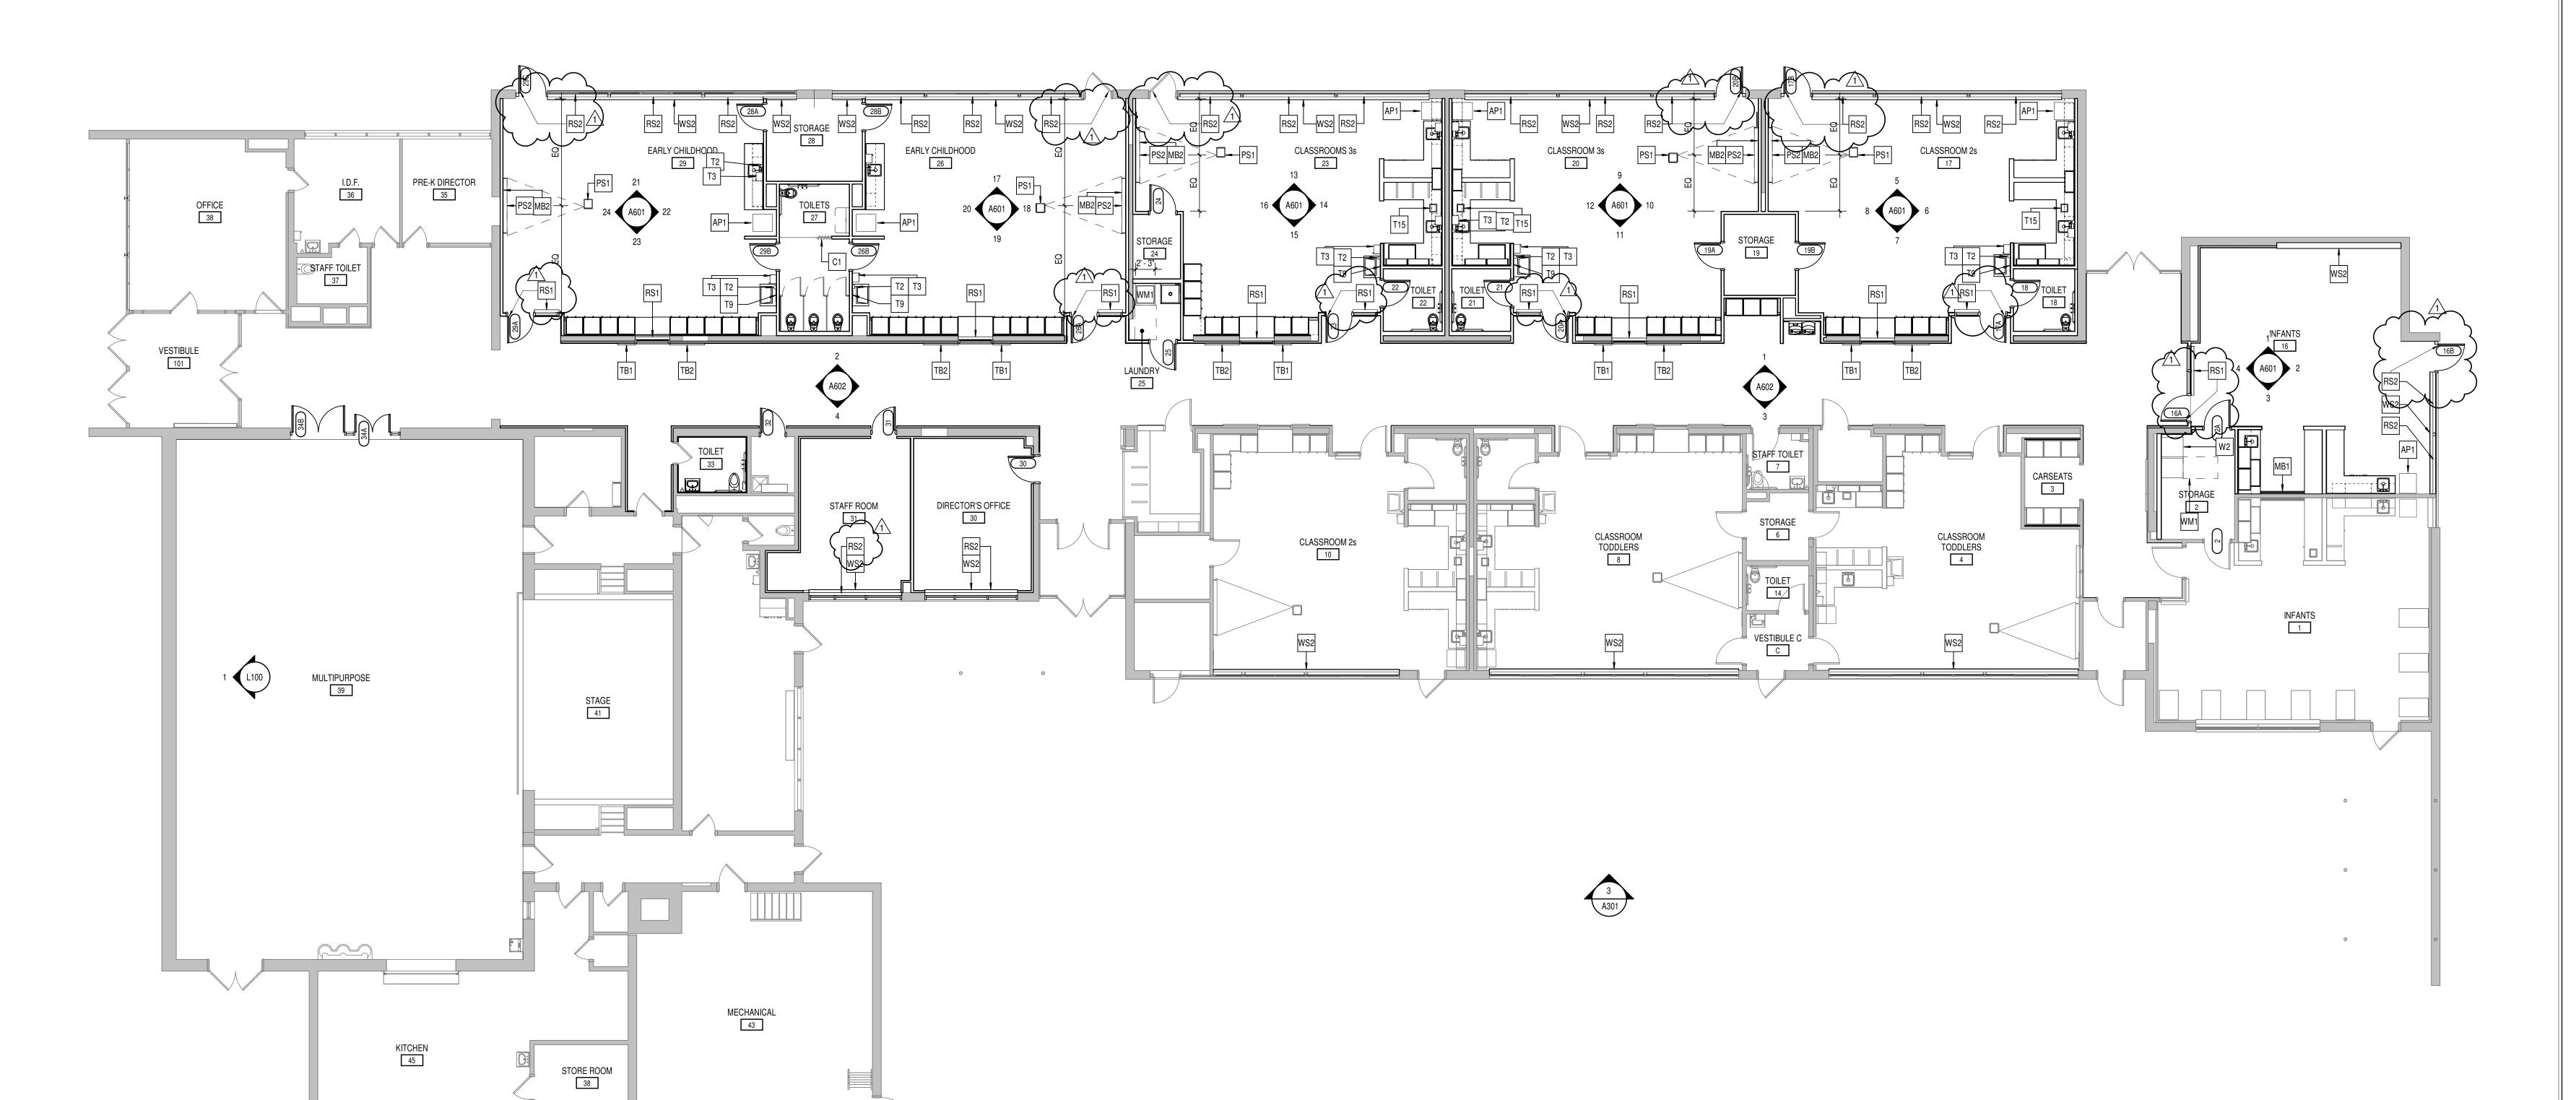

FIRST FLOOR EQUIPMENT PLAN

SCALE: 1/8" = 1'-0"

NORTH



S831 Keystone Crossing, Indianapolis, IN 46240 317.848.7800 | csoinc.net

BARTHOLOMEW COUNTY SCHOOL
CORPORATION
RENOVATIONS TO
AICHARD L. JOHNSON EEC
1209 S SYCAMORE ST, COLUMBUS, IN 47201

SCOPE DRAWINGS:

These drawings indicate the general scope of the project in terms of architectural design concept, the dimensions of the building, the major architectural elements and the type of structural, mechanical and electrical systems.


The drawings do not necessarily indicate or describe all work required for full performance and completion of the requirements of the Contract.

On the basis of the general scope indicated or described, the trade contractors shall furnish all items required for the proper execution and completion of the work.

REVISIONS:
ADDENDUM #1 12-03-2024

ISSUE DATE DRAWN BY CHECKED BY
11/20/2024 JAG ECN

EQUIPMENT
SCHEDULE &
FIRST FLOOR
EQUIPMENT
PLAN

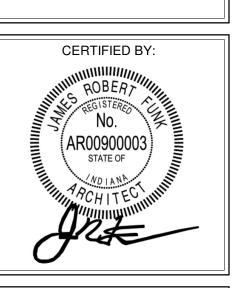

A900