

BOUNDARY AND TOPOGRAPHIC SURVEY INFORMATION PROVIDED BY CENTRAL STATES CONSULTING, LLC.. PROJECT NUMBER 23-080, DATED 11-27-2023.

BOUNDARY AND TOPOGRAPHIC SURVEY INFORMATION PROVIDED BY H.GIBSON LAND SURVEYING, LLC. PROJECT NUMBER 21-322, DATED 10-08-2021

### **GENERAL NOTES**

- 1. THE DEMOLITION PLAN IS BASED ON INFORMATION PROVIDED ON THE TOPOGRAPHIC SURVEY. CONTRACTOR IS RESPONSIBLE FOR VISITING THE SITE AND COMPARING THE DOCUMENTS TO THE FIELD CONDITIONS. IF DISCREPANCIES OCCUR, CONTRACTOR SHALL IMMEDIATELY NOTIFY THE ENGINEER OF RECORD.
- 2. THE CONTRACTOR SHALL REMOVE AND DISPOSE ALL EXISTING STRUCTURES, STONE, CONCRETE AND PAVEMENT OFF SITE UNLESS NOTED TO REMAIN ON THE CONTRACT DRAWINGS.
- THE CONTRACTOR SHALL PROTECT AND NOT DESTROY THE PROPERTY CORNER MONUMENTS DURING CONSTRUCTION. IF A MONUMENT IS MOVED OR DAMAGED, THE CONTRACTOR SHALL IMMEDIATELY NOTIFY THE ENGINEER AND SURVEYOR OF RECORD.
- THIS SECTION REQUIRES THE REMOVAL AND DISPOSAL, OFF SITE, OF THE FOLLOWING:
- a. SPECIFIED OBJECTS
- b. VEGETATION WITHIN THE WORK AREA.
- CONTRACTOR SHALL SUBMIT THE FOLLOWING IN ACCORDANCE WITH CONDITIONS OF THE CONTRACT AND APPROPRIATE SPECIFICATION
- a. A DETAILED SEQUENCE AND SCHEDULE OF DEMOLITION AND REMOVAL WORK TO BE COMPLETED.
- JOB CONDITIONS
   a. SALVAGED MATERIALS: ITEMS OF SALVAGEABLE VALUE TO
   CONTRACTOR MAY BE REMOVED FROM SITE AS WORK

   DROCKESSES TRANSPORT SALVACED ITEMS FROM THE SITE AS
- PROGRESSES. TRANSPORT SALVAGED ITEMS FROM THE SITE AS THEY ARE REMOVED.

  b. STORAGE OR SALE OF REMOVED ITEMS WILL NOT BE
- PERMITTED ON SITE.

  c. EXPLOSIVES: USE OF ANY TYPE OF EXPLOSIVES WILL NOT BE
- PERMITTED.
- d. TRAFFIC: CONDUCT DEMOLITION OPERATIONS AND REMOVAL OF DEBRIS TO ENSURE MINIMUM INTERFERENCE WITH ROADS, STREETS, WALKS AND OTHER ADJACENT OCCUPIED AND USED FACILITIES.
- e. DO NOT CLOSE OR OBSTRUCT ROADS, STREETS, WALKS OR OTHER OCCUPIED OR USED FACILITIES WITHOUT PERMISSION FROM THE LOCAL AUTHORITIES HAVING JURISDICTION. PROVIDE ALTERNATE ROUTES AROUND CLOSED OR OBSTRUCTED TRAFFIC WAYS, IF REQUIRE BY GOVERNING AUTHORITIES.
- f. PROTECTIONS: ENSURE SAFE PASSAGE OF PERSONS AROUND AREAS OF DEMOLITION, CONDUCT OPERATIONS TO PREVENT DAMAGE TO ADJACENT BUILDINGS, STRUCTURES, AND OTHER FACILITIES AND INJURY TO PERSONS.
- g. DAMAGES: PROMPTLY REPAIR ANY DAMAGES CAUSED TO ADJACENT FACILITIES BY DEMOLITION OPERATIONS.
- h. UTILITY SERVICES: MAINTAIN EXISTING UTILITIES TO STAY IN SERVICE AND PROTECT AGAINST DAMAGE DURING DEMOLITION OPERATIONS. DISCONNECT, CAP AND REMOVE UTILITY SERVICES PER LOCAL REQUIREMENTS. DO NOT START DEMOLITION WORK UNTIL UTILITY DISCONNECTIONS HAVE BEEN COMPLETED TO THE SATISFACTION OF LOCAL UTILITIES. (AS REQUIRED)
- a. BELOW-GRADE CONSTRUCTION: DEMOLISH FOUNDATION WALLS AND BELOW-GRADE CONSTRUCTION, INCLUDING CONCRETE SLABS TO A DEPTH OF NOT LESS THAN 48 INCHES BELOW LOWEST FOUNDATION LEVEL.
- b. FILLING VOIDS: COMPLETELY FILL BELOW-GRADE AREAS AND VOIDS RESULTING FROM DEMOLITION. BACK FILL TO BE COMPACTED TO 90% STANDARD PROCTOR OR 98% ON NEW
- STRUCTURES.

  DISPOSAL OF DEMOLISHED MATERIALS

DEMOLITION

- a. GENERAL: REMOVE WEEKLY FROM SITE ACCUMULATED DEBRIS, RUBBISH AND OTHER MATERIALS RESULTING FROM
- DEMOLITION OPERATIONS.b. REMOVAL: TRANSPORT MATERIALS REMOVED FROM DEMOLITION OPERATIONS AND LEGALLY DISPOSE OF OFF-SITE.
- TEMPORARY TRAFFIC CONTROL DURING DEMOLITION AND CONSTRUCTION SHALL CONFORM TO APPLICABLE LOCAL AND STATE STANDARDS.

# EXISTING LEGEND

SEE EXITING TOPOGRAPHY PLAN

REVISIONS

NO. DATE DESCRIPTION


1 1/6/25 ADD. 1

ISSUE DATE: 12/13/2024

RAWN BY CHECKED BY GCD

DRAWING TITLE

DEMOLITION PLAN

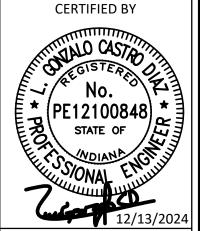



PROJECT NUMBER 2024.0244

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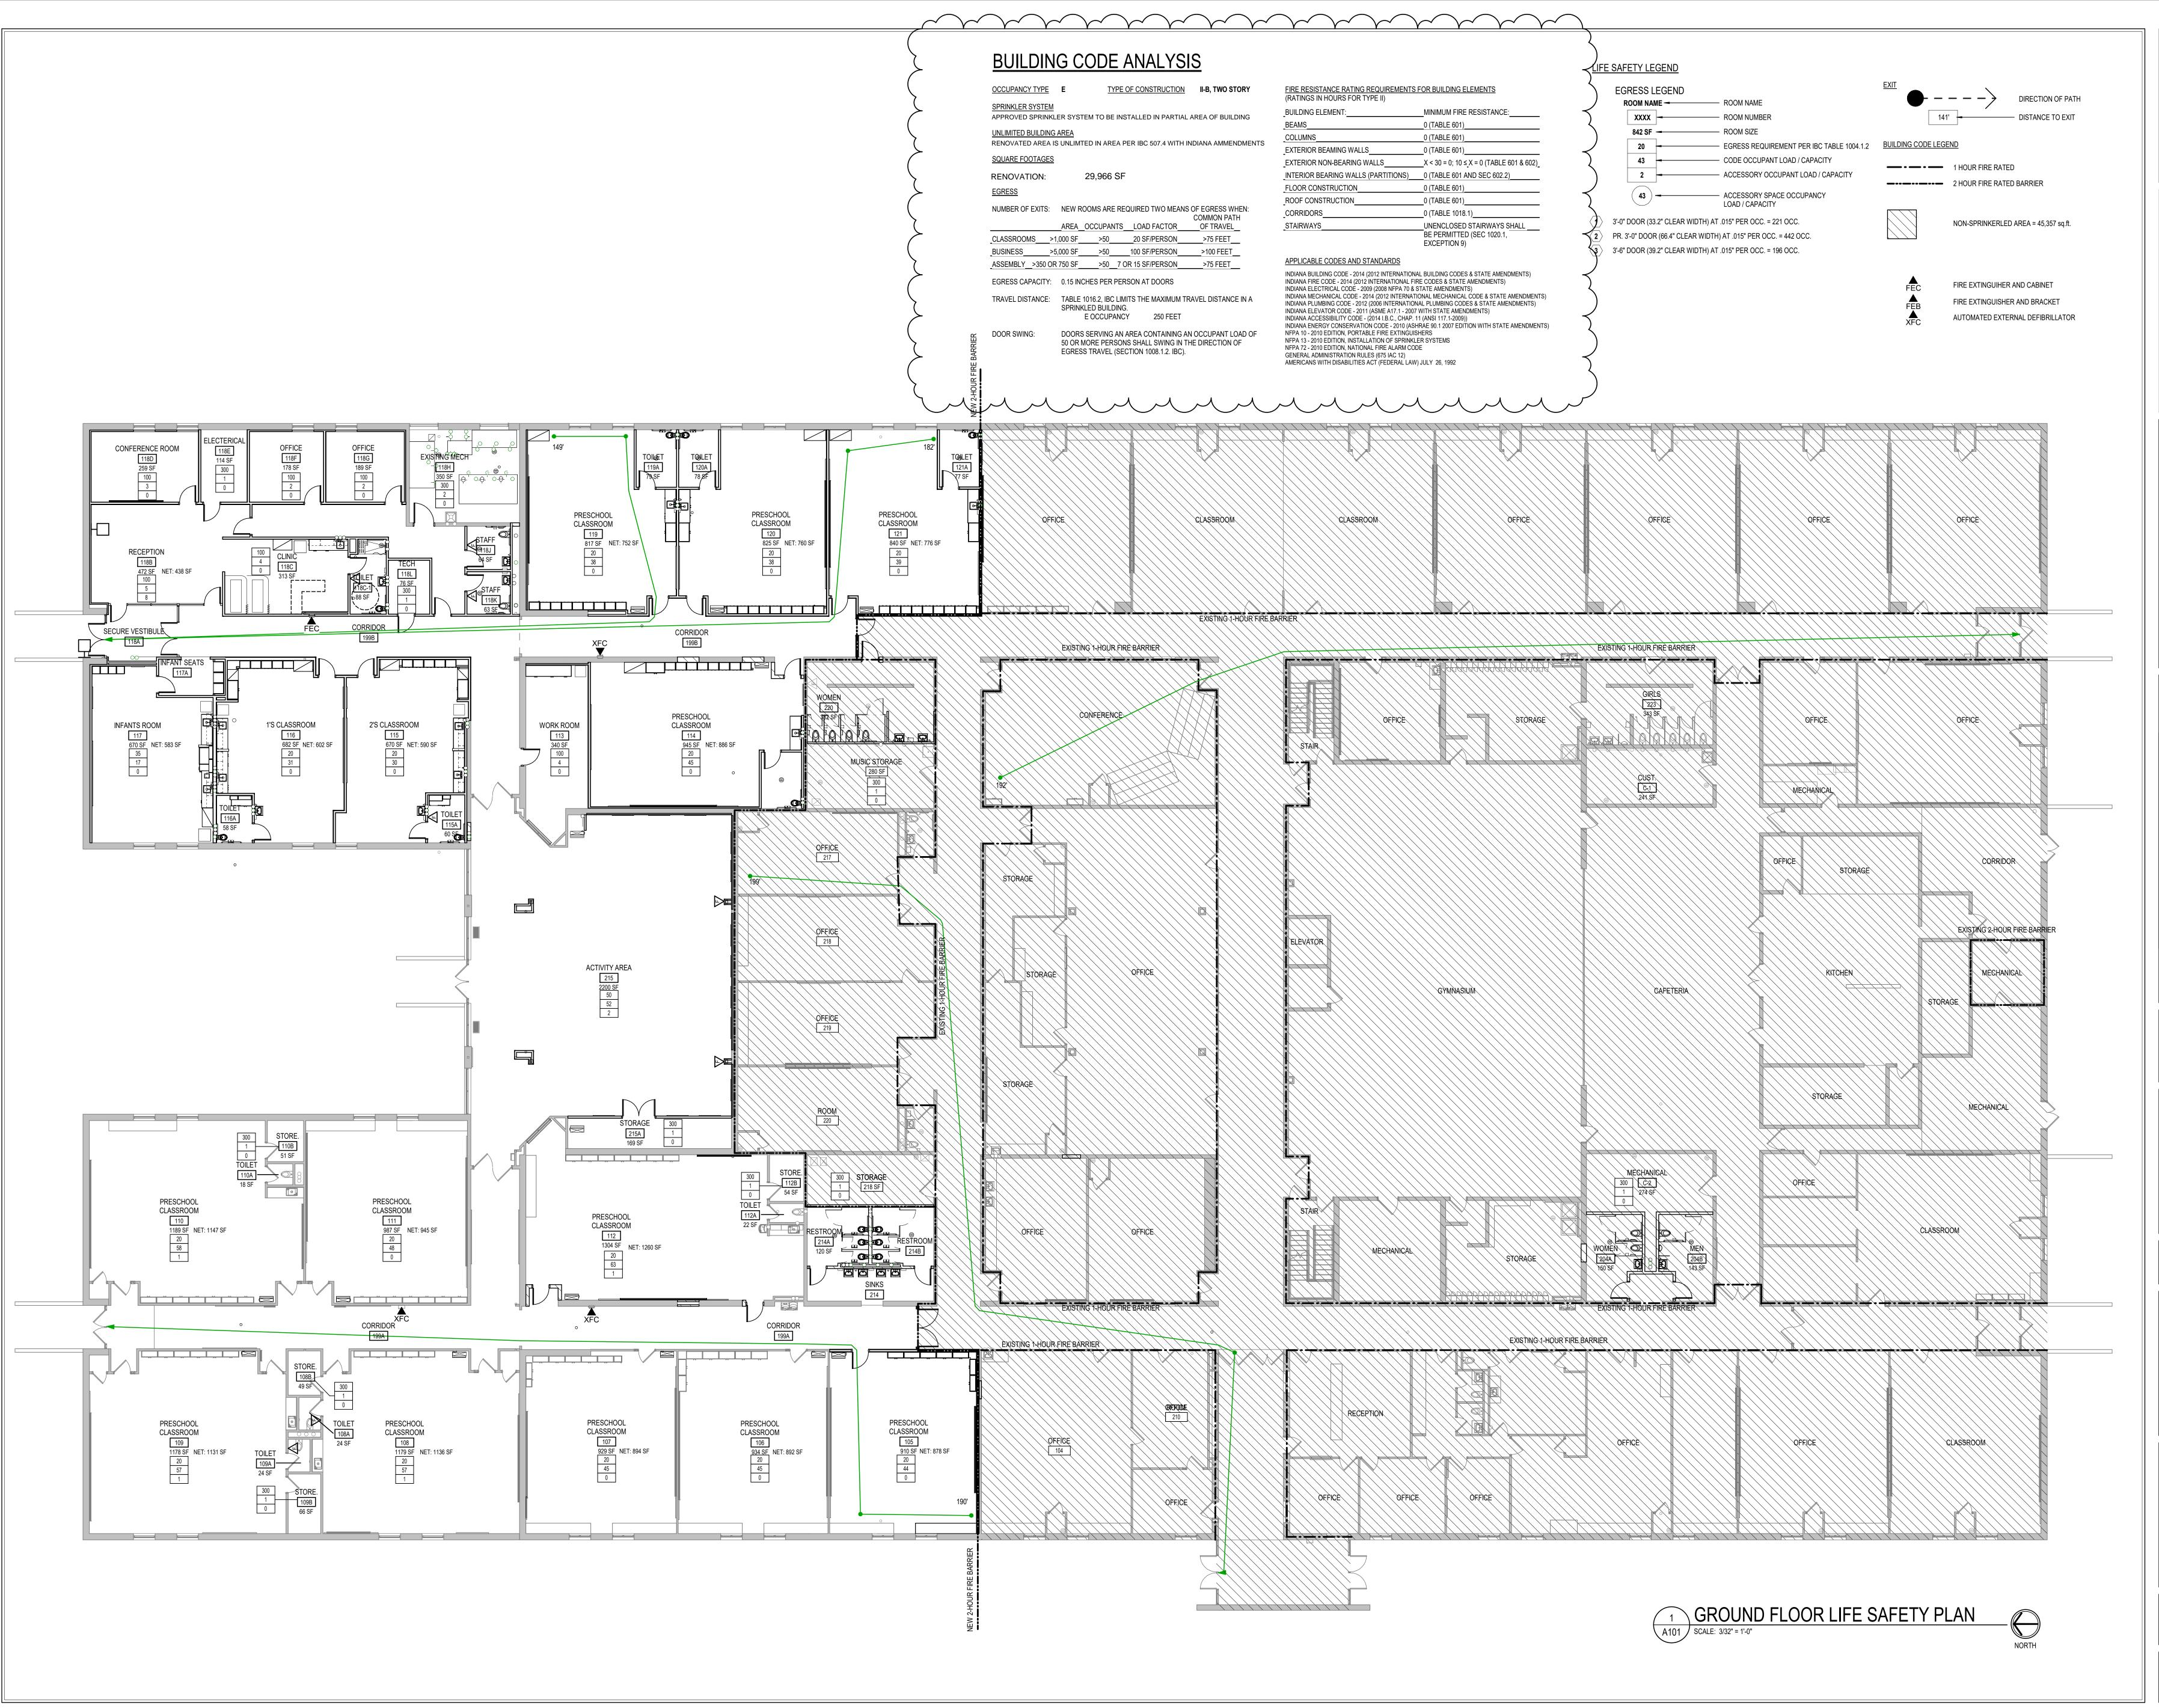
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BENCHMARK DATA





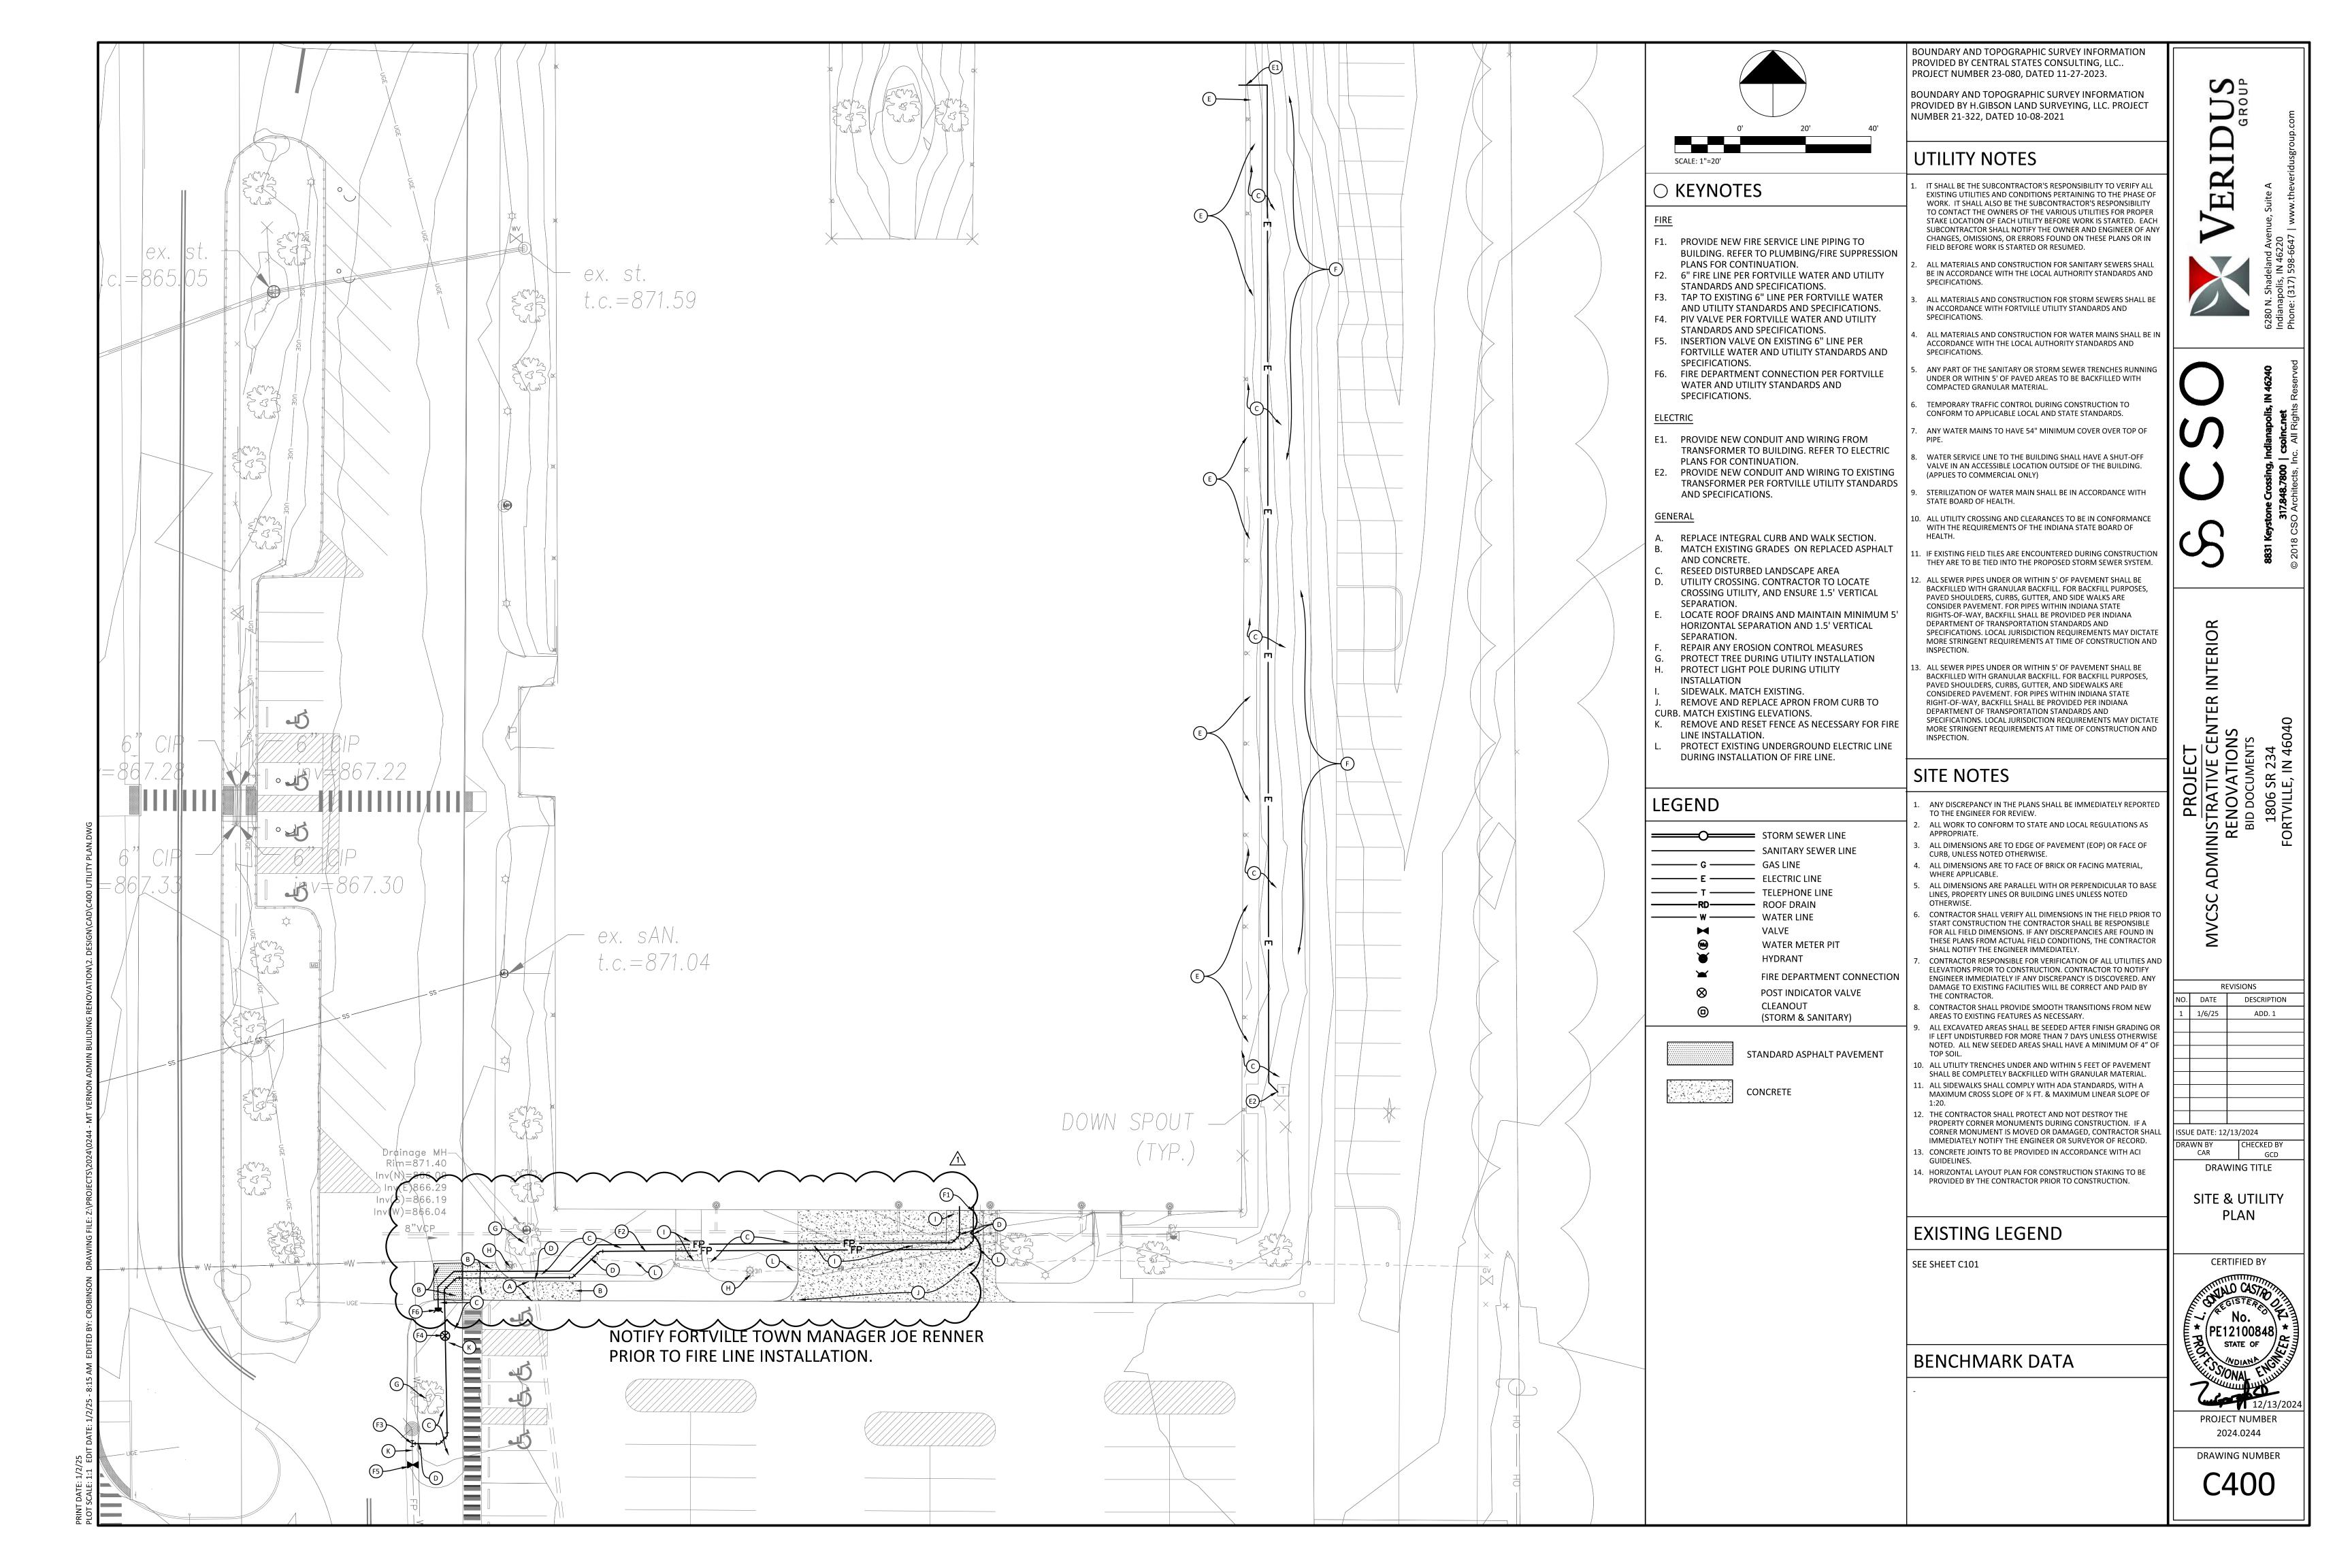

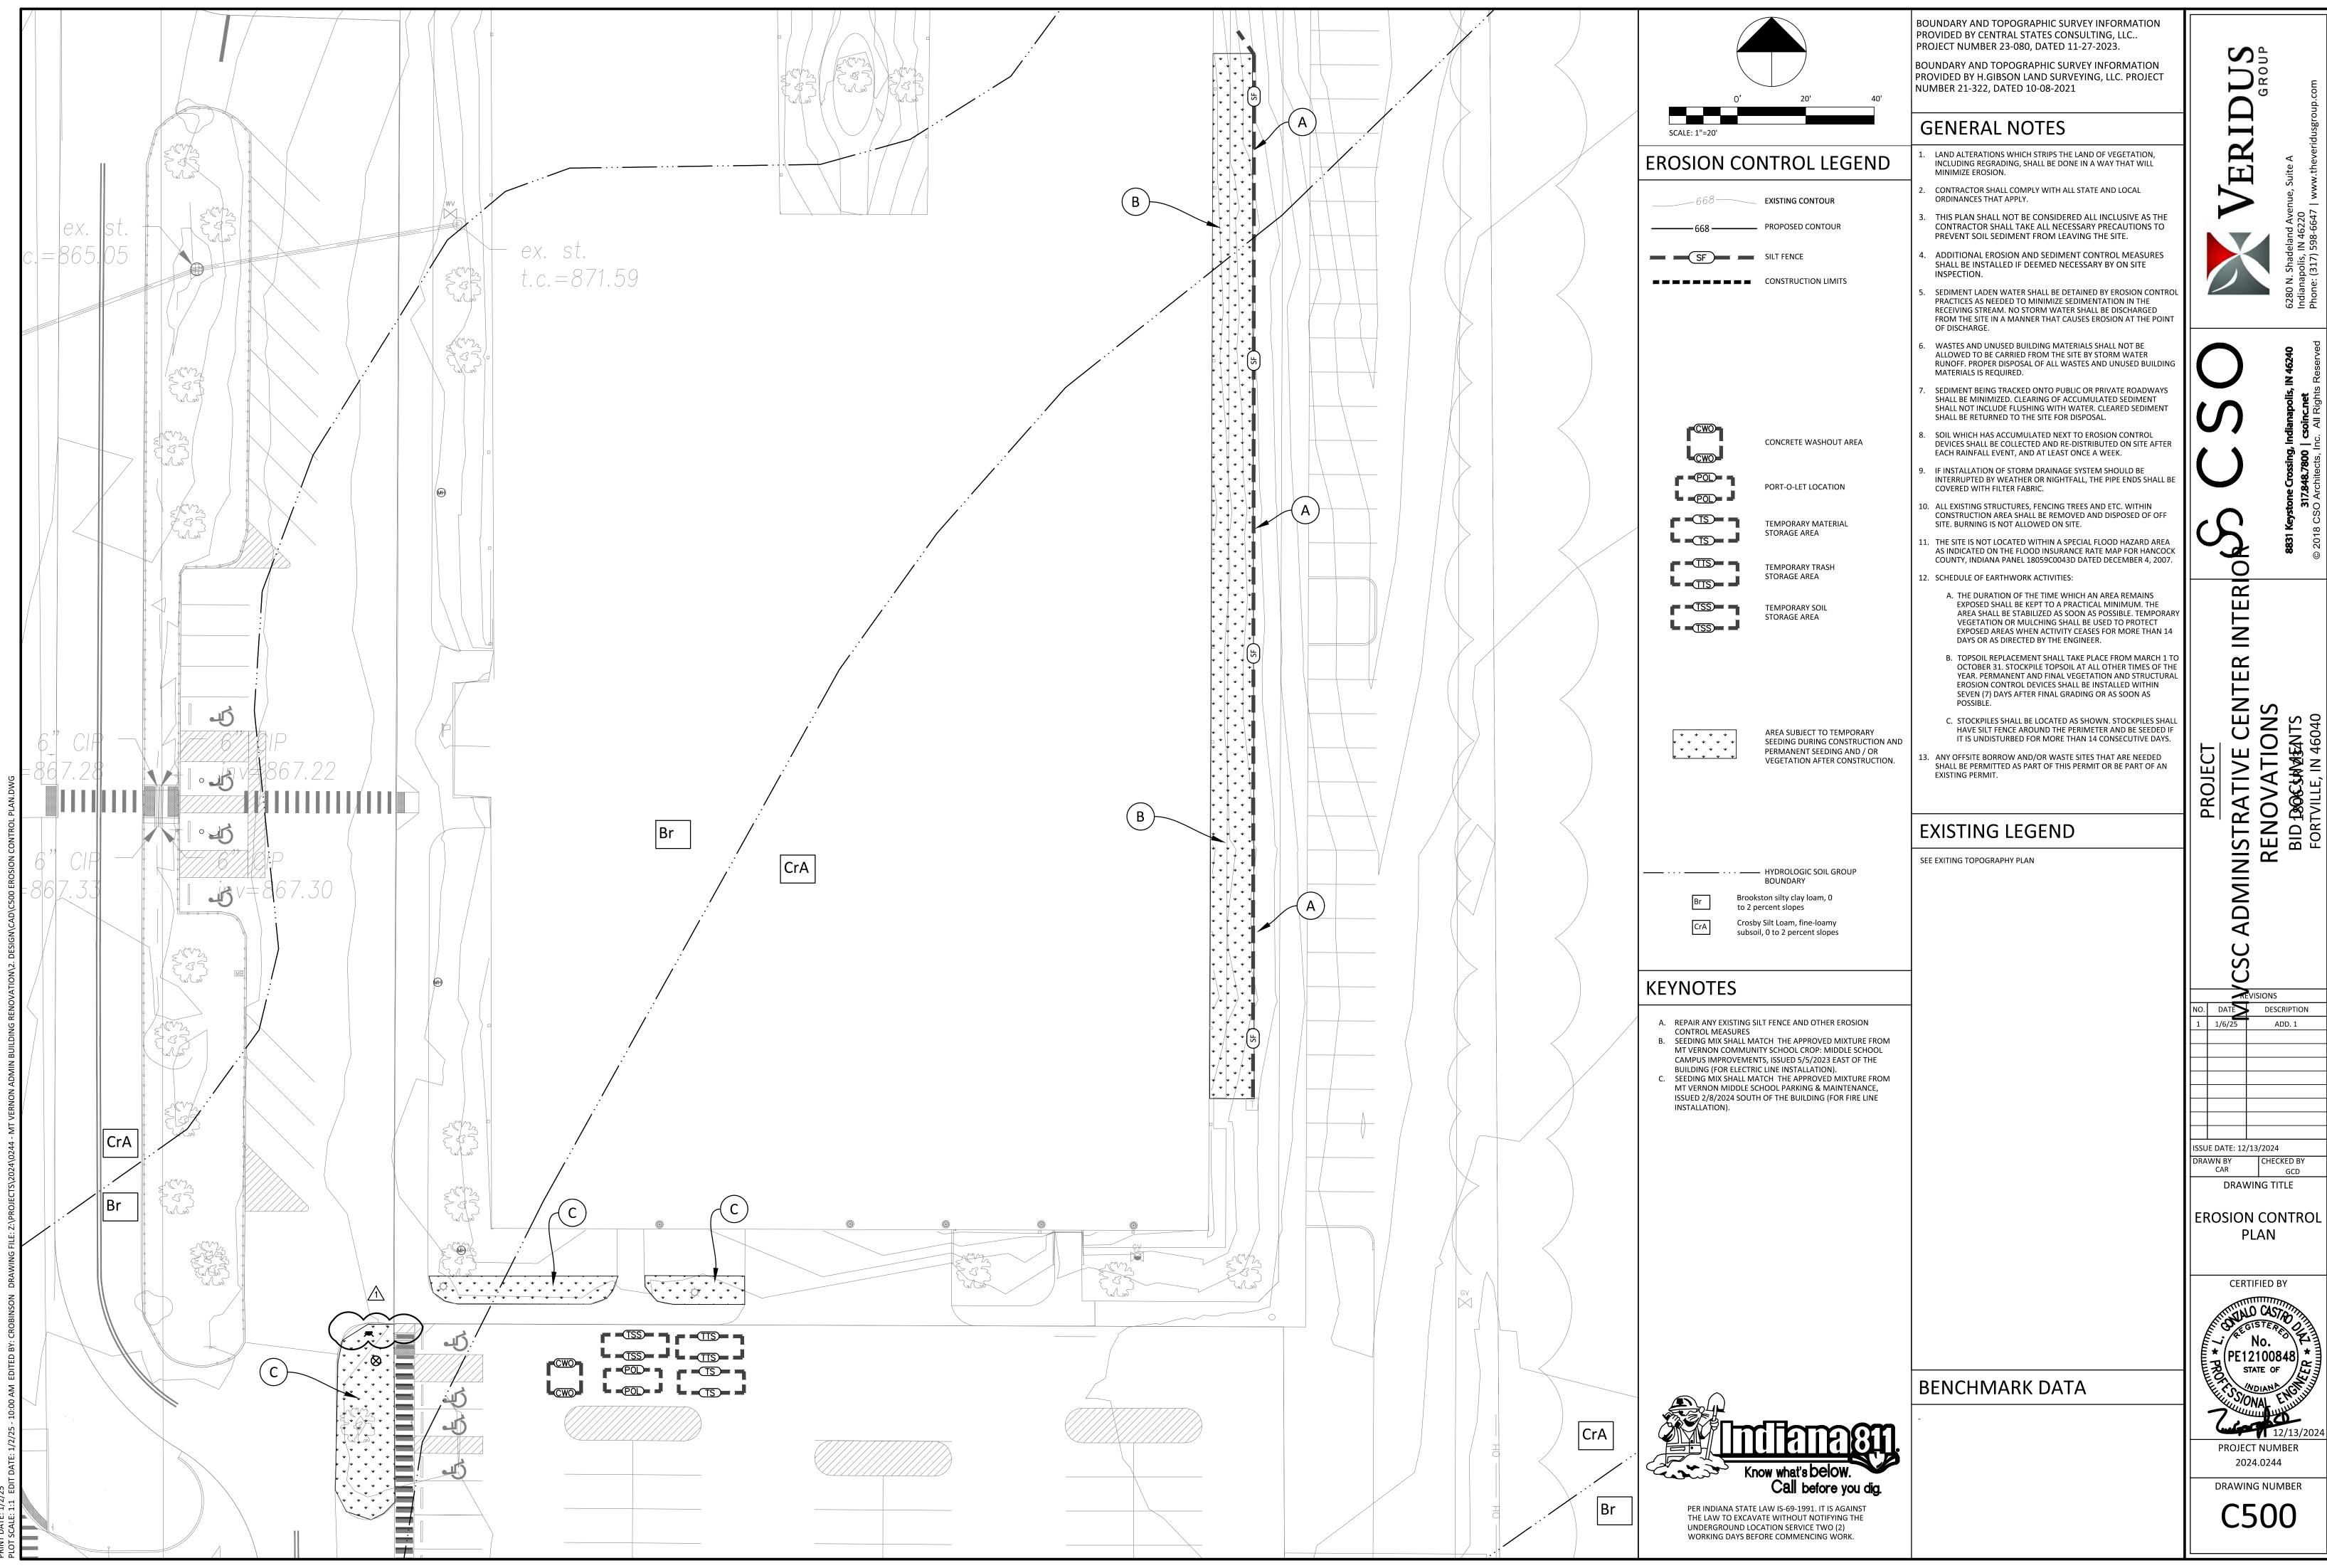



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AECOM HUN

MVCSC ADMINISTRATIVE CENTEI INTERIOR RENOVATIONS BID DOCUMENTS 1806 SR 234 FORTVILLE, IN 46040

SCOPE DRAWINGS:

These drawings indicate the general scope of the project in terms of architectural design concept, the dimensions of the building, the major architectural elements and the type of structural, mechanical and electrical systems.

The drawings do not necessarily indicate or describe all work required for full performance and completion of the requirements of the Contract.

On the basis of the general scope indicated or described, the trade contractors shall furnish all items required for the proper execution and completion of the work.

REVISIONS:


ADDENDUM #1 01/06/25

ISSUE DATE DRAWN BY CHECKED BY 12/02/2024 NS EHMH


DRAWING TITLE:

GROUND FLOOR

GROUND FLOOR
LIFE SAFETY
PLAN

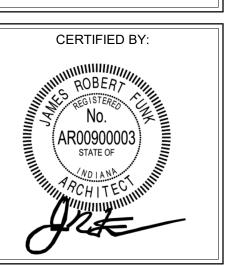

DRAWING NUMBER

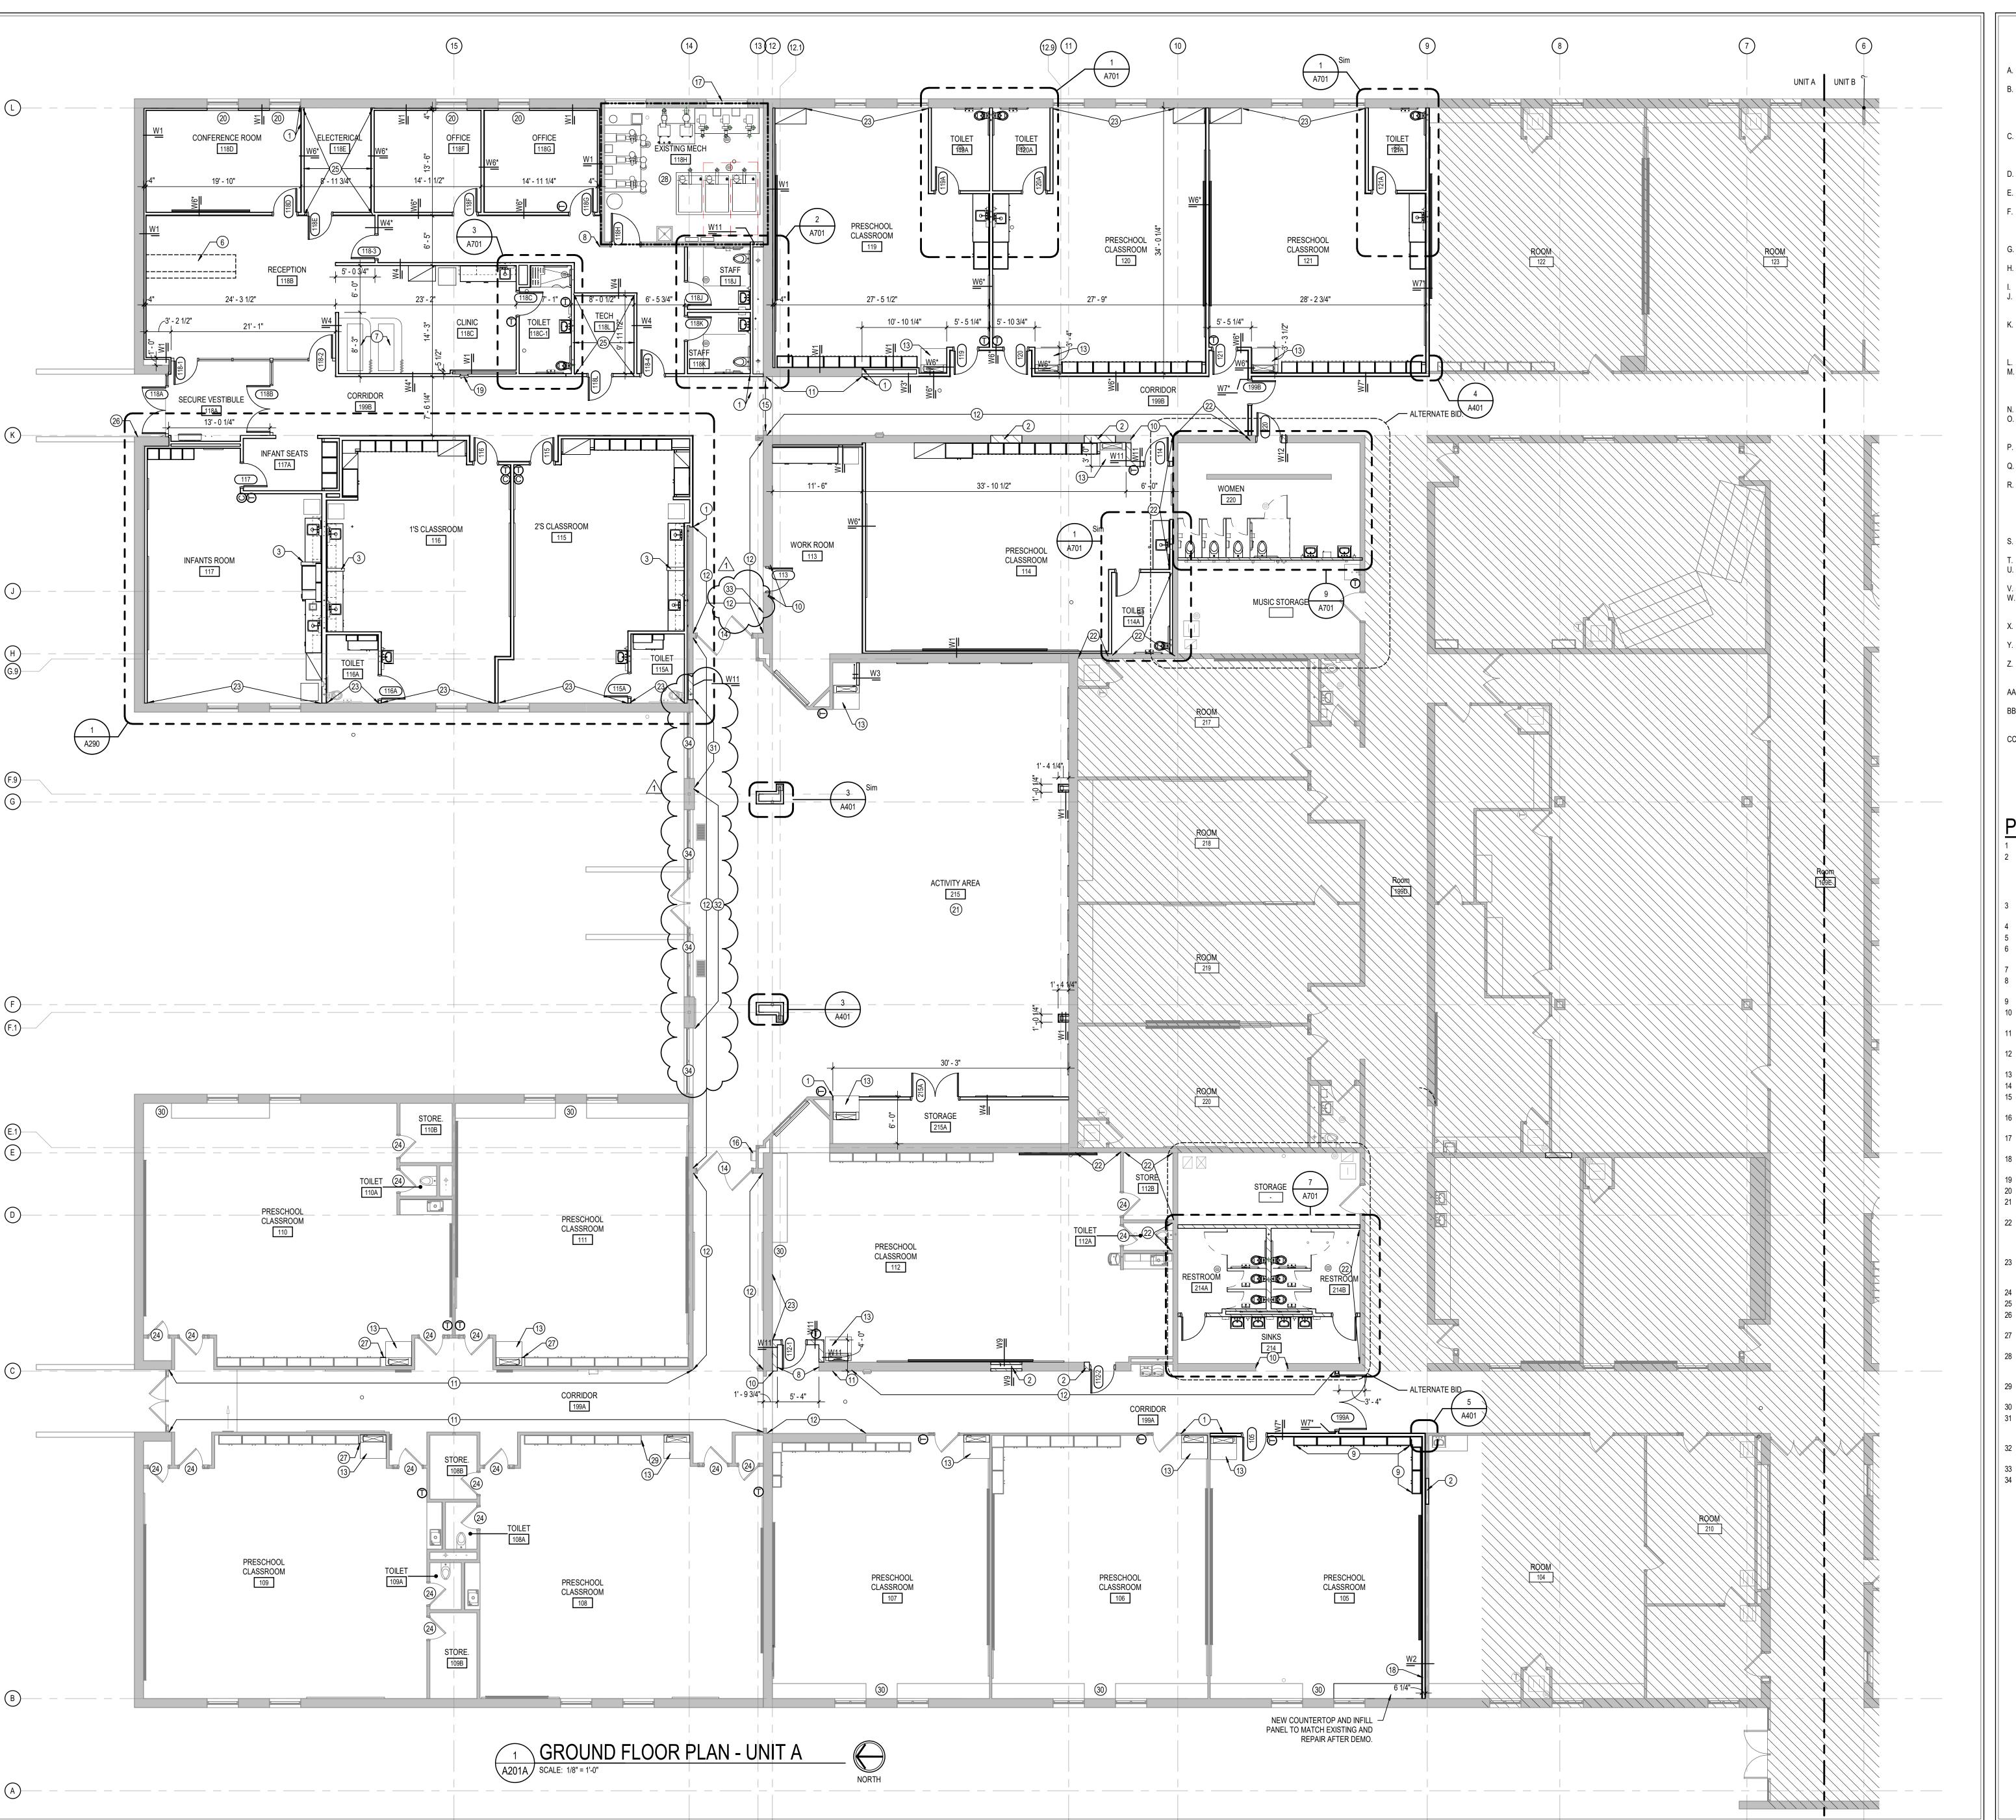

# **GENERAL NOTES**

COORDINATE THE WORK OF EACH TRADE WITH THE WORK OF OTHER

- ALL WORK IS TO BE COMPLETED IN STRICT ACCORDANCE WITH ALL APPLICABLE CODES, ORDINANCES, RULES, REGULATIONS AND STANDARDS INCLUDING, BUT NOT LIMITED TO THOSE LISTED ON THE COVER SHEET. ALL APPLICABLE RULES & REGULATIONS ARE TO BE THE MOST CURRENT
- ADOPTED EDITIONS. FIELD VERIFY EXISTING CONDITIONS AND DIMENSIONS PRIOR TO THE
- COMMENCEMENT OF WORK. DISCREPANCIES BETWEEN THE DOCUMENTS AND THE ACTUAL CONDITIONS SHALL BE BROUGHT TO THE ATTENTION OF THE ARCHITECT PRIOR TO THE COMMENCEMENT OF WORK. ALL DIMENSIONS ARE FROM CENTERLINE OF STRUCTURE, FINISH FACE OF
- WALL, FACE OF MASONRY, OR FACE OF EXISTING. ANY DIMENSIONS NOT SHOWN OR DEEMED QUESTIONABLE ARE TO BE
- VERIFIED BY ARCHITECT. DO NOT SCALE DRAWINGS. REFER TO WALL TYPE SCHEDULE, SHEET A200, TO DETERMINE WHICH WALLS EXTEND TO DECK. SEE STRUCTURAL FOR TOP SUPPORT DETAIL. WHERE METAL STUDS EXTEND TO DECK, PROVIDE SLIP CONNECTIONS FOR ROOF/
- FLOOR DEFLECTION. ALL STEEL STUDS ARE TO BE BRACED ACCORDING TO MANUFACTURER LIMIT HEIGHT (L/240).
- WHERE INSULATED OR SOUND WALLS EXTEND TO DECK, FILL DECK FLUTES WITH INSULATION/ SOUND ATTENUATION. REFER TO PLUMBING PLANS FOR LOCATION OF FLOOR DRAINS.
- WHERE ACCESS PANELS ARE SHOWN IN TOILET ROOM CHASES, FINAL LOCATION SHALL BE COORDINATED WITH OTHER TRADES PRIOR TO INSTALLATION. ALL CONCRETE MASONRY UNITS (CMU) SHALL BE LAID STACKED BOND U.N.O.
- CMU WALLS THAT DO NOT LAY OUT IN FULL OR HALF LENGTHS SHOULD BE BALANCED SO AS NOT TO HAVE ANY PIECES LESS THAN 4" IN SIZE EXPOSED
- ALL OUTSIDE CMU CORNERS SHALL BE BULLNOSED. ALL INTERIOR MASONRY WALLS THAT RUN TO UNDERSIDE OF DECK ABOVE SHALL HAVE A 2" JOINT (U.N.O.) AT THE DECK TO BE FILLED WITH FIRE

STOPPING AT RATED WALLS PER PROJECT MANUAL, AND MINERAL WOOL AT

THE NON-RATED WALLS TO ALLOW FOR DEFLECTION. PROVIDE MISCELLANEOUS SUPPORT FOR ALL CEILING SUSPENDED ITEMS. DOOR AND FRAME NUMBERS CORRESPOND TO ROOM NUMBERS. WHERE MORE THAN ONE DOOR OCCURS IN A ROOM, A SUFFIX HAS BEEN ADDED (E.G. A100-1). SEE A500 SERIES DRAWINGS FOR DOOR SCHEDULE AND DETAILS.

ALL DOOR FRAMES SHALL BE LOCATED 4" OFF FINISH WALLS OR 4" OFF

- MASONRY WALLS UNLESS NOTED OTHERWISE. ALL GLASS AT INTERIOR DOOR FRAMES, DOOR LITES AND WINDOW FRAMES IS TO BE 1/4" CLEAR TEMPERED GLASS UNLESS NOTED OTHERWISE. AT BUILDING EXPANSION JOINTS, ALL PARTITIONS, CEILINGS, FLOORS AND ALL WALL, FLOOR OR CEILNG MOUNTED ITEMS SHALL BE ANCHORED TO THE BUILDING STRUCTURE ON ONLY ONE SIDE OF THE EXPANSIONS JOINTS.
- ITEMS NOTED TO ASSURE THAT NO SUCH ITEMS BRIDGE ACCROSS THE EXPANSION JOINT. ALL SLAB-ON-GRADE CONTROL JOINTS TO BE CLEANED AND CAULKED PRIOR

CONTRACTOR SHALL COORDINATE CONSTRUCTION OR INSTALLATION OF ALL


TO PLACEMENT OF FLOOR FINISH. SEE REFLECTED CEILING PLANS FOR BULKHEAD LOCATIONS AND DETAILS. REFER TO MECHANICAL DRAWINGS FOR WALL LOUVER LOCATIONS, SIZES AND QUANTITIES.

REQUIRED FOR ALL SURFACE MOUNTED ITEMS.

- SEE A800 SERIES DRAWINGS FOR FINISH SCHEDULE AND PLANS. SEE A900 SERIES DRAWINGS FOR EQUIPMENT SCHEDULE AND PLANS.
- PROVIDE BLOCKING IN STUD WALLS AND/OR GROUTED MASONRY CORES AS REQUIRED TO SUPPORT EQUIPMENT. PROVIDE FIRE RESISTANT TREATED WOOD BLOCKING SUPPORTS AS
- WHERE DISIMILAR FLOOR MATERIALS MEET, THEY SHALL DO SO UNDER THE CENTERLINE OF THE DOOR UNLESS NOTED OTHERWISE. APPLY SEALANT AT ALL JUNCTURES BETWEEN DIFFERENT MATERIALS (E.G.
- MASONRY TO GYPSUM WALL BOARD) UTILIZING THE APPROPRIATE TYPE PER SPECIFICATIONS. COLOR TO BE SELECTED BY ARCHITECT. AA. APPLY SEALANT AT ALL COUNTERTOPS AND BLACKSPLASHES AT JUNCTURE
- BB. ALL DOORS MUST BE INSTALLED WITH AT LEAST THE MINIMUM MANEUVERING CLEARANCE AT THE DOOR APPROACH PER THE MOST CURRENT AMERICANS
- WITH DISABILITIES ACT. CC. BASE FLOOR ELEVATION INDICATED FOR THIS PROJECT IS 100'-0". REFER TO SITE PLAN FOR CORRELATION TO USGS DATUM.

## **PLAN NOTES**

- ALIGN FINISH FACE AS INDICATED INFILL OPENING WITH NEW WALL CONSTRUCTION AS REQUIRED TO MATCH ADJACENT WALL MATERIAL. WHERE INFILL IS EXPOSED IN THE FINISH WORK, MATCH EXISTING BRICK OR BLOCK AS REQUIRED, TOOTHED IN TO MATCH EXISTING COURSING. PREPARE SURFACES FOR INSTALLATION OF NEW FINISH AS INDICATED
- ON A800 SERIES. PARTIAL HEIGHT WALL, WITH SOLID SURFACE COUNTER TOP. SEE ENLARGED
- PLANS ON A290 SERIES FOR WALL TYPE. CHILD HANDWASH SINK. SEE PLUMBING DRAWINGS.
- WATER COOLER AND/OR BOTTLE FILLER. SEE PLUMBING DRAWINGS. FURNITURE FOR RECEPTION DESK, COORDINATE TECH AND POWER HOOK UPS WITH FURNITURE SUPPLIER
- CUBICLE CURTAIN AND RADIUS TRACK. SEE A900 SERIES. PATCH AND REPAIR CMU WALL WERE ADJACENT WALL WAS DEMO'D PROVIDE NEW
- BULLNOSED OUTSIDE CORNER REINSTALL EXISTING CASEWORK AS DIRECTED BY OWNER.
- 10 TOOTH IN NEW BRICK OR BLOCK TO MATCH EXISTING COURSING. PROVIDE BULLNOSE AT ALL OUTSIDE CORNERS
- PROVIDE NEW PAINT OVER EXISTING TEXTURED GYPSUM WALL FINISH. PAINT PER
- PROVIDE NEW PAINT OVER EXISTING ACRYLIC TEXTURED CMU WALL FINISH. PAINT PER A800 SERIES.
- 13 VUV. SEE MECHANICAL DRAWINGS.
- 14 EXISTING DOOR AND FRAME TO REMAIN, PAINT DOOR AND FRAME. 15 PATCH AND REPAIR GYPSUM WALLBOARD JAMB WHERE DOOR AND FRAME WERE REMOVED, PREP FOR PAINT.
- 16 EXISTING TO REMAIN AED CABINET AND SIGNAGE, REMOVE TO PAINT AND REINSTALL IN SAME CONIDITION AND LOCATION
- PROVIDE INSULATED BLANK-OFF PANEL. COORDINATE WITH MECHANICAL
- 18 NEW W2 WALL CAN NOT ATTACH TO EXISTING WALL. NEW WALL SHOULD ACHIEVE STC RATING 58 TESTED TO USG 040910. WALL TO ATTACH TO DECK.
- 19 FIRE EXTINGUISHER CABINET. SEE EQUIPMENT PLANS. 20 PROVIDE SOLID SURFACE WINDOW SILLS. SEE A800 SERIES.
- 21 ALL GYPSUM WALLS IN THIS ROOM SHALL BE IMPACT RESITANT GYPSUM WALLBOARD FROM FLOOR LEVEL TO MIN +6' AFF.
- 2 WALL REQUIRED TO BE 2 HOUR FIRE BARRIER, EXTEND EXISTING CMU WALL TO DECK WITH 2 HOUR RATED STUD AND GYPSUM WALL ASSEMBLY, SEAL ALL
- PENERATIONS WITH FIRE STOPING, PATCH REPAIR AND INFILL ANY ALL ALL EXISTING OPENINGS LEFT BY DEMOLITON OF EXISTING EQUIPMENT
- WHERE CASEWORK WAS REMOVED FROM EXISITNG WALL, PATCH, PREP AND REPAIR EXISITNG WALL SURFACE, INCLUDING RETOOL EXISITNG CMU JOINTS, DUE
- TO WALL NOW BEING EXPOSED TO VIEW TO ROOM 24 PAINT EXISTING METAL DOOR FRAME, COMPLETE.
- 25 EXTEND ALL WALLS INDICATED TO ROOF DECK ABOVE. 26 PROVIDE NEW SURFACE MOUNTED KNOX BOX AT THIS LOCATION, COORDINATE
- 27 PROVIDE PLASTIC LAMIANTE FILLER OR TRIM BETWEEN VUV AND EXISITNG
- CASEWORK TO REMAIN, COLOR AS SELECTED. 28 MECHANICAL ROOM HAS EXISTING 2-HOUR RATING, EXISTING RATING SHALL BE MAINTANED IN THIS ROOM, SEAL ALL PENTERATIONS, DUCT OPENINGS, ETC. AS
- REQ'D TO MAINTAIN RATING 9 PROVIDE PLASTIC LAMIANTE END PANEL ON EXPOSED TO VIEW END OF EXISITNG
- CASEWORK TO REMAIN, COLOR AS SELECTED.
- 0 PAINT EXISTING CASEWORK TO MATCH ADJACENT. 1 REPAIR CRACK IN MASONRY JOINT. CUT OUT EXISITNG MORTAR MATERIAL AND
- TUCK POINT. PROVIDE A MINIMUM OF 12 LINEAR FEET OF TUCKPOINTING AT LOCATION SHOWN.
- 32 REMOVE EXISTING WALL ANCHORS IN MASONRY WALL. PATCH AND REPAIR WALL
- TO MATCH EXISTING.
- 33 REPLACE EXISTING SURFACE MOUNTED WIRE MOLD ON WALL. 34 REMOVE EXISTING BLIND HARDWARE COMPLETE.

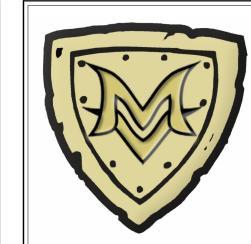

SCOPE DRAWINGS: proper execution and completion of the work.

ADDENDUM #1 01/06/25

REVISIONS:

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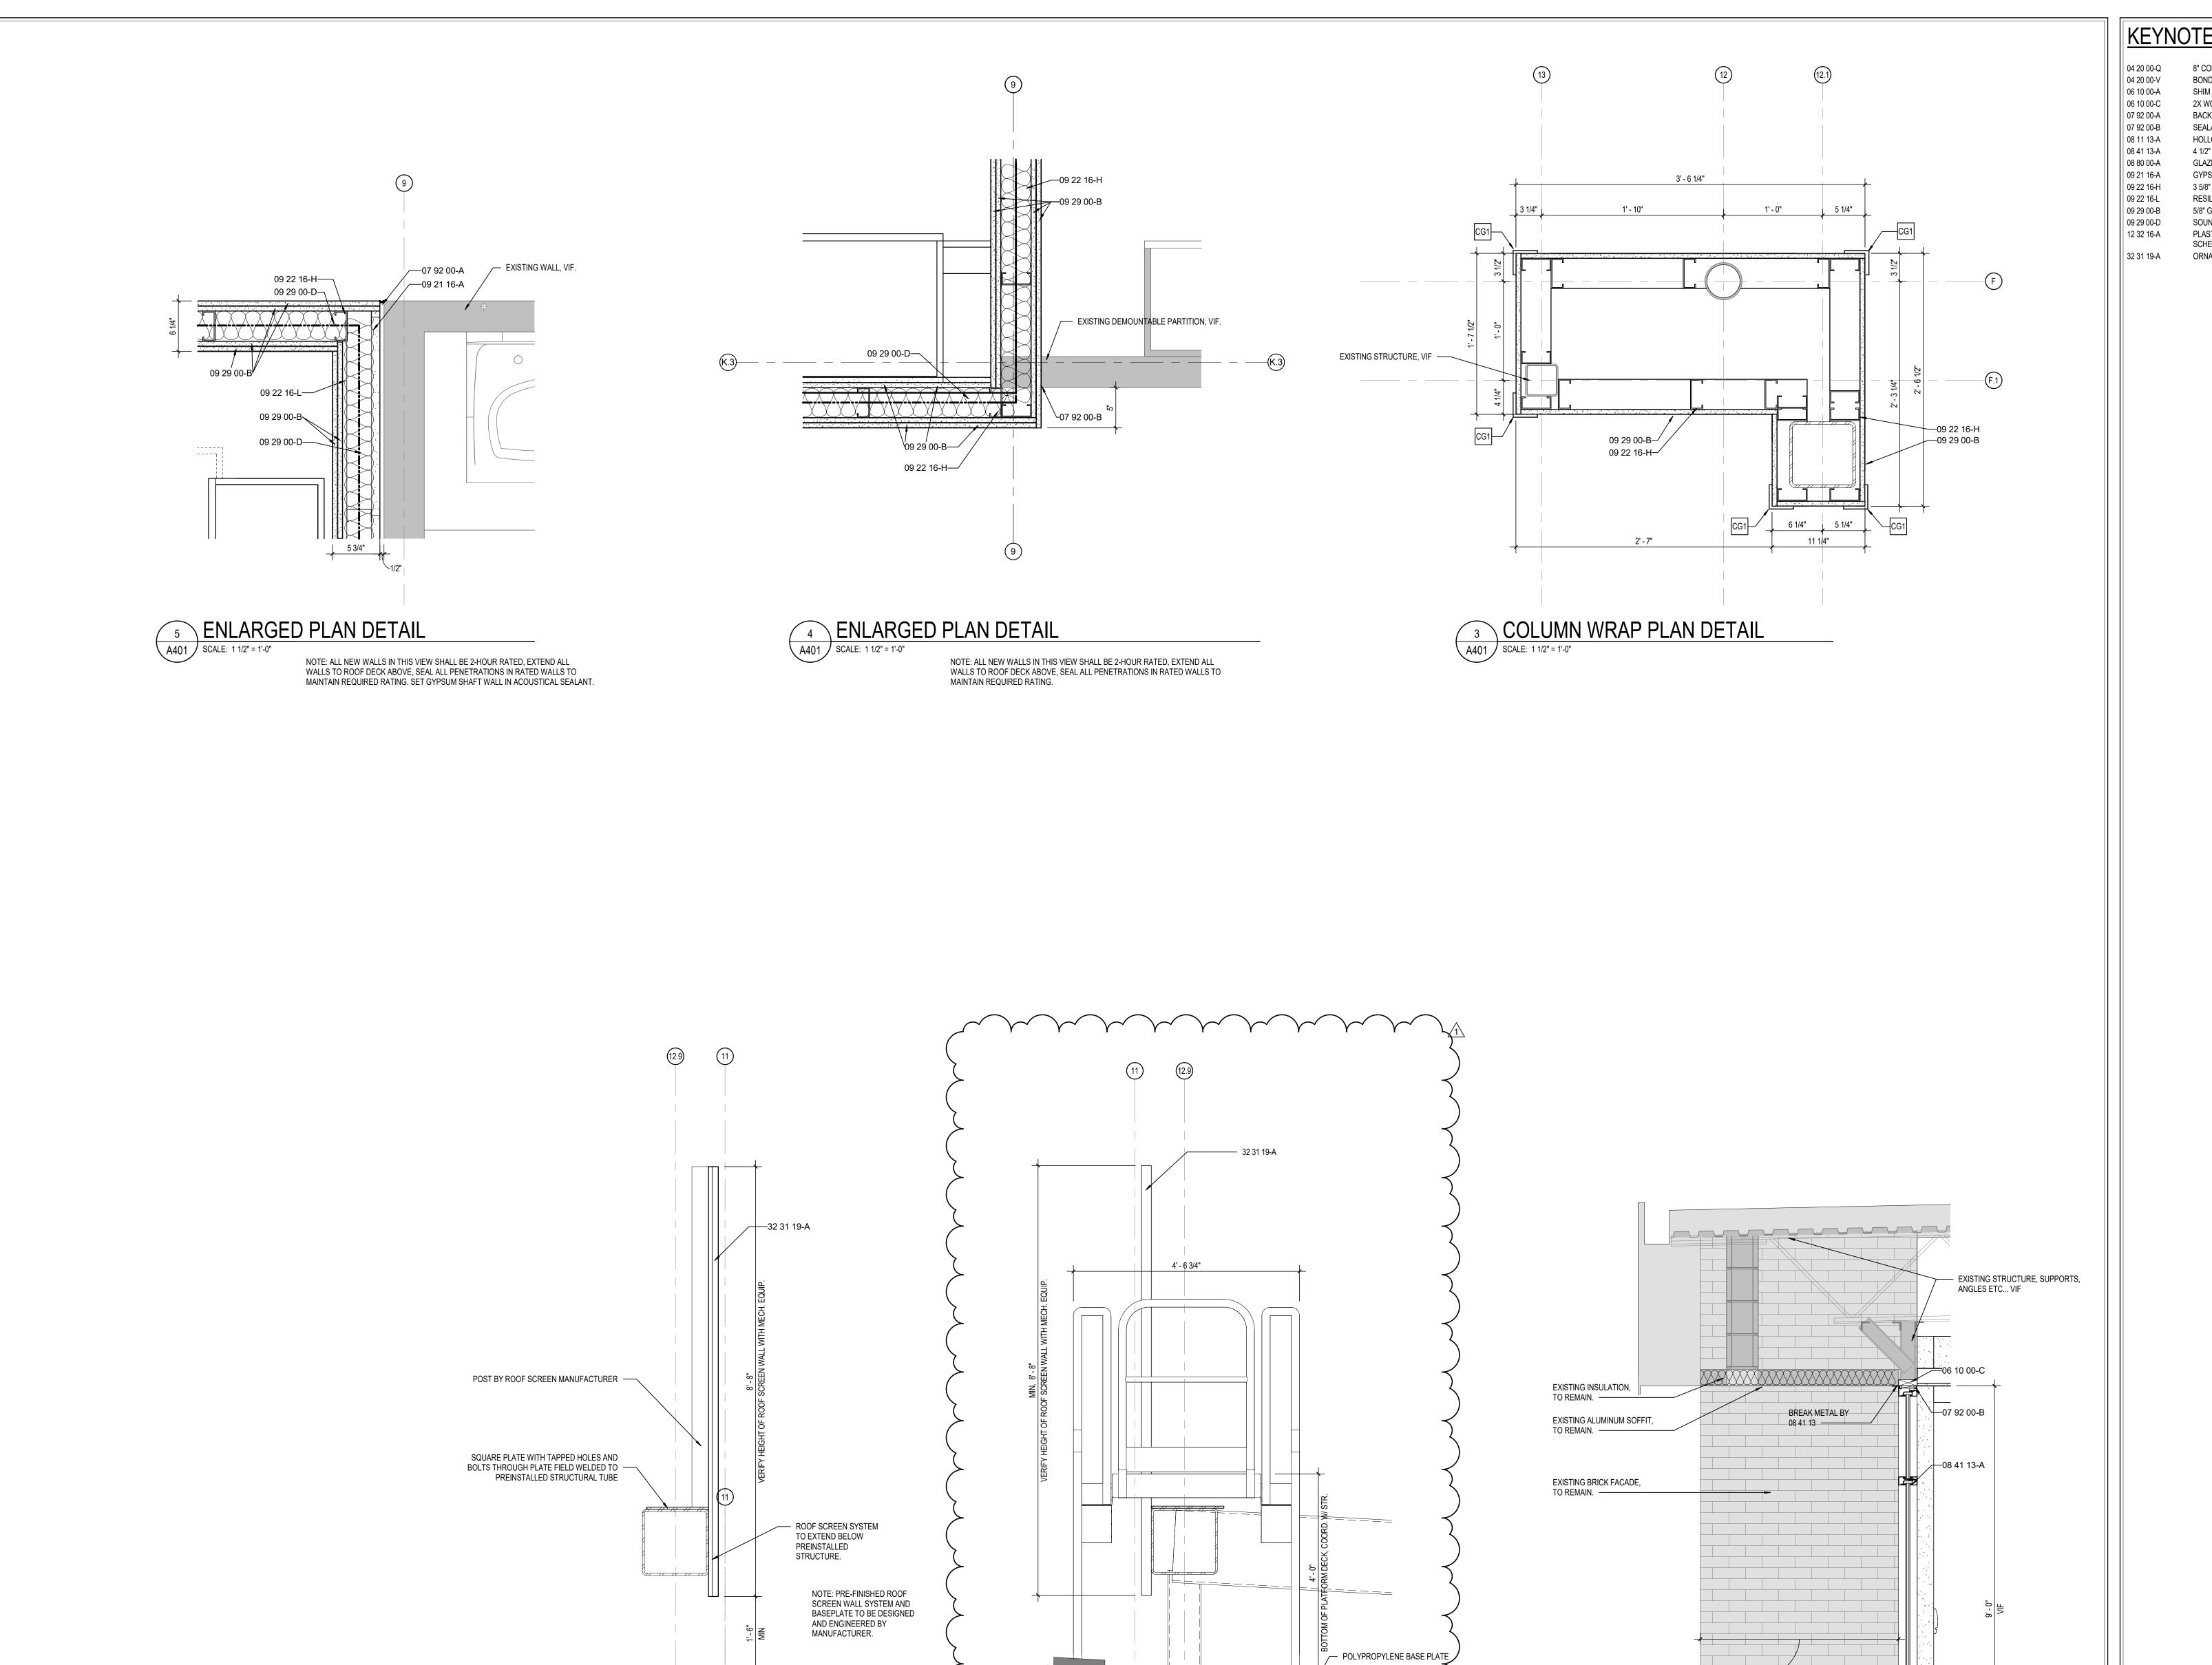
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DRAWING TITLE: GROUND FLOOR PLAN - UNIT A

12/02/2024

CERTIFIED BY:

DRAWING NUMBER A201A



VIF. NEW STORFRONT FRAME, INSTALLED AT SAME LOCATION AS EXISITNG

1 WALL SECTION

SCALE: 3/4" = 1'-0"

-07 92 00-B -06 10 00-A

6 WALL SECTION

SCALE: 3/4" = 1'-0"

# KEYNOTE LEGEND

8" CONCRETE MASONRY UNIT BOND BEAM MASONRY UNIT SHIM AS REQUIRED 2X WOOD BLOCKING BACKER ROD AND SEALANT SEALANT EACH SIDE, TYPICAL

HOLLOW METAL DOOR/BORROWED LIGHT FRAME 4 1/2" ALUMINUM-FRAMED STOREFRONT GLAZING - SEE SCHEDULE/ELEVATIONS GYPSUM BOARD SHAFT WALL ASSEMBLIES- 4" CH STUD

3 5/8" STEEL STUD RESILIENT CHANNEL 5/8" GYPSUM WALL BOARD (SEE SPECS FOR TYPE) SOUND ATTENUATION INSULATION

PLASTIC LAMINATE INSTITUTIONAL CASEWORK- SEE EQUIPMENT 32 31 19-A ORNAMENTAL FENCE- SEE CIVIL SHEETS

SCOPE DRAWINGS:

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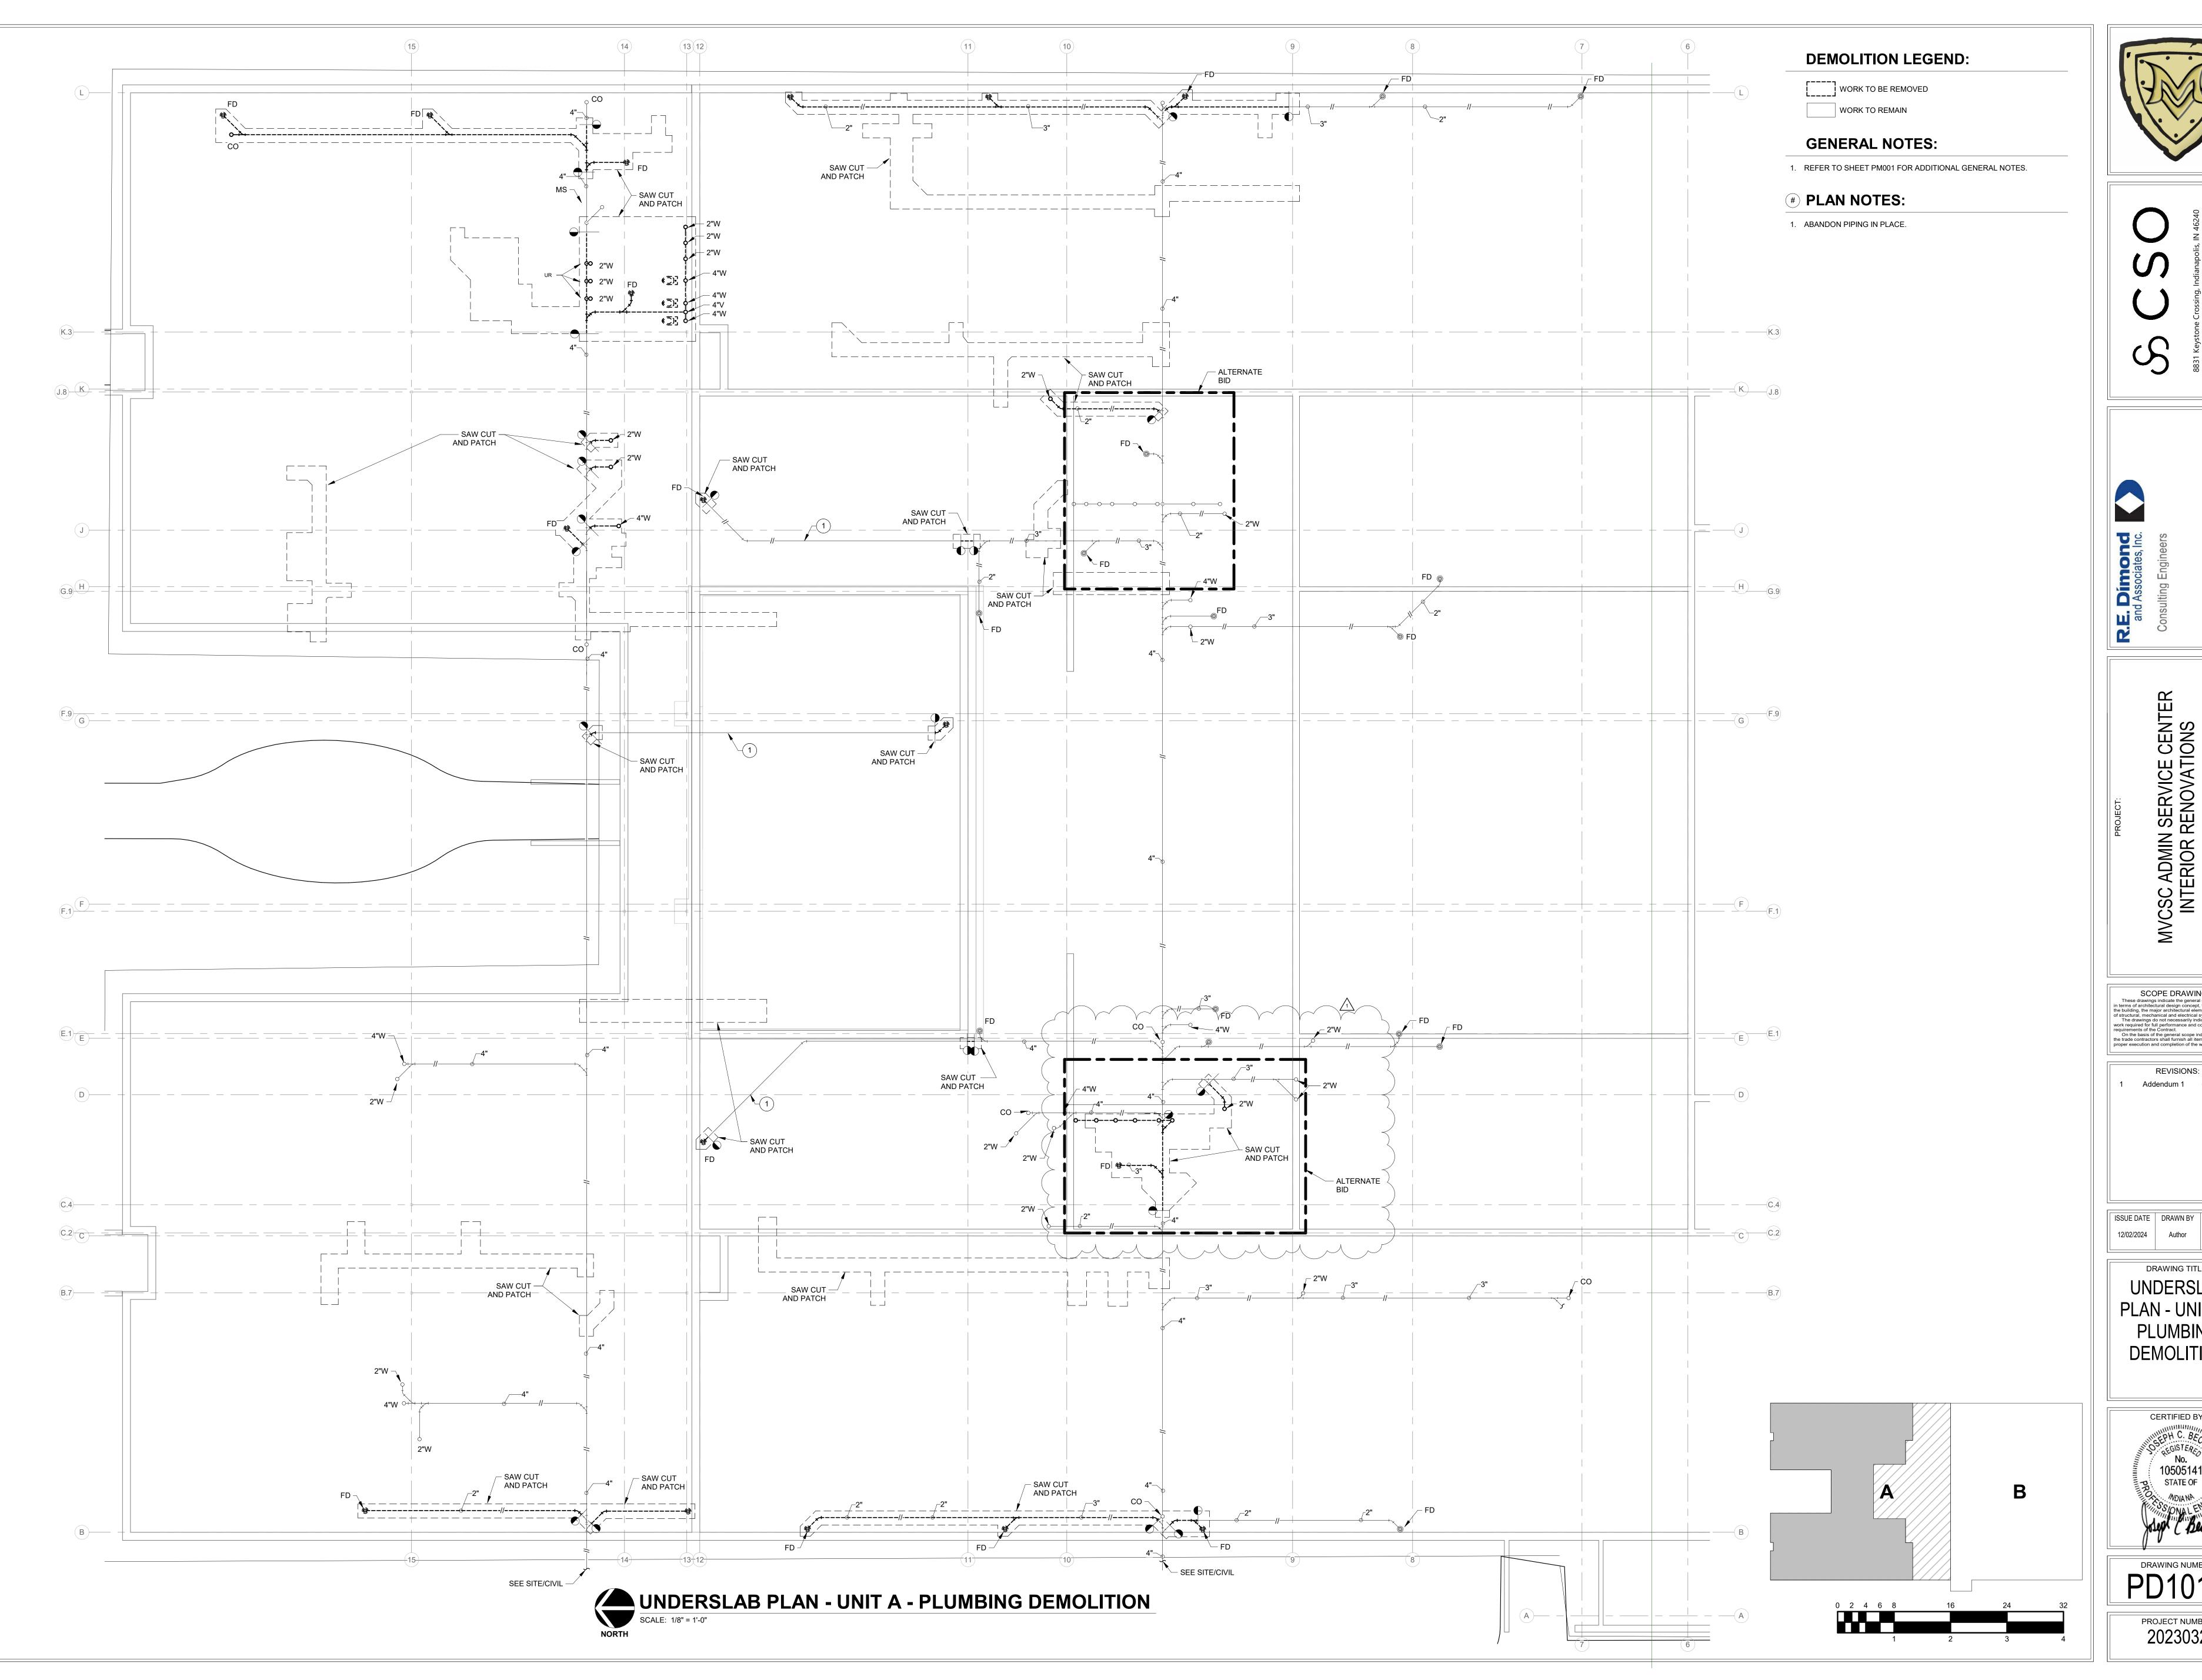
> REVISIONS: ADDENDUM #1 01/06/25

ISSUE DATE | DRAWN BY | CHECKED BY 12/02/2024 XXX

DRAWING TITLE: WALL SECTIONS

CERTIFIED BY:

DRAWING NUMBER A401





SCOPE DRAWINGS:

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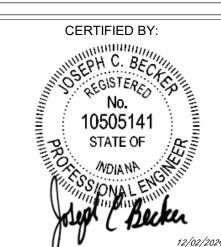
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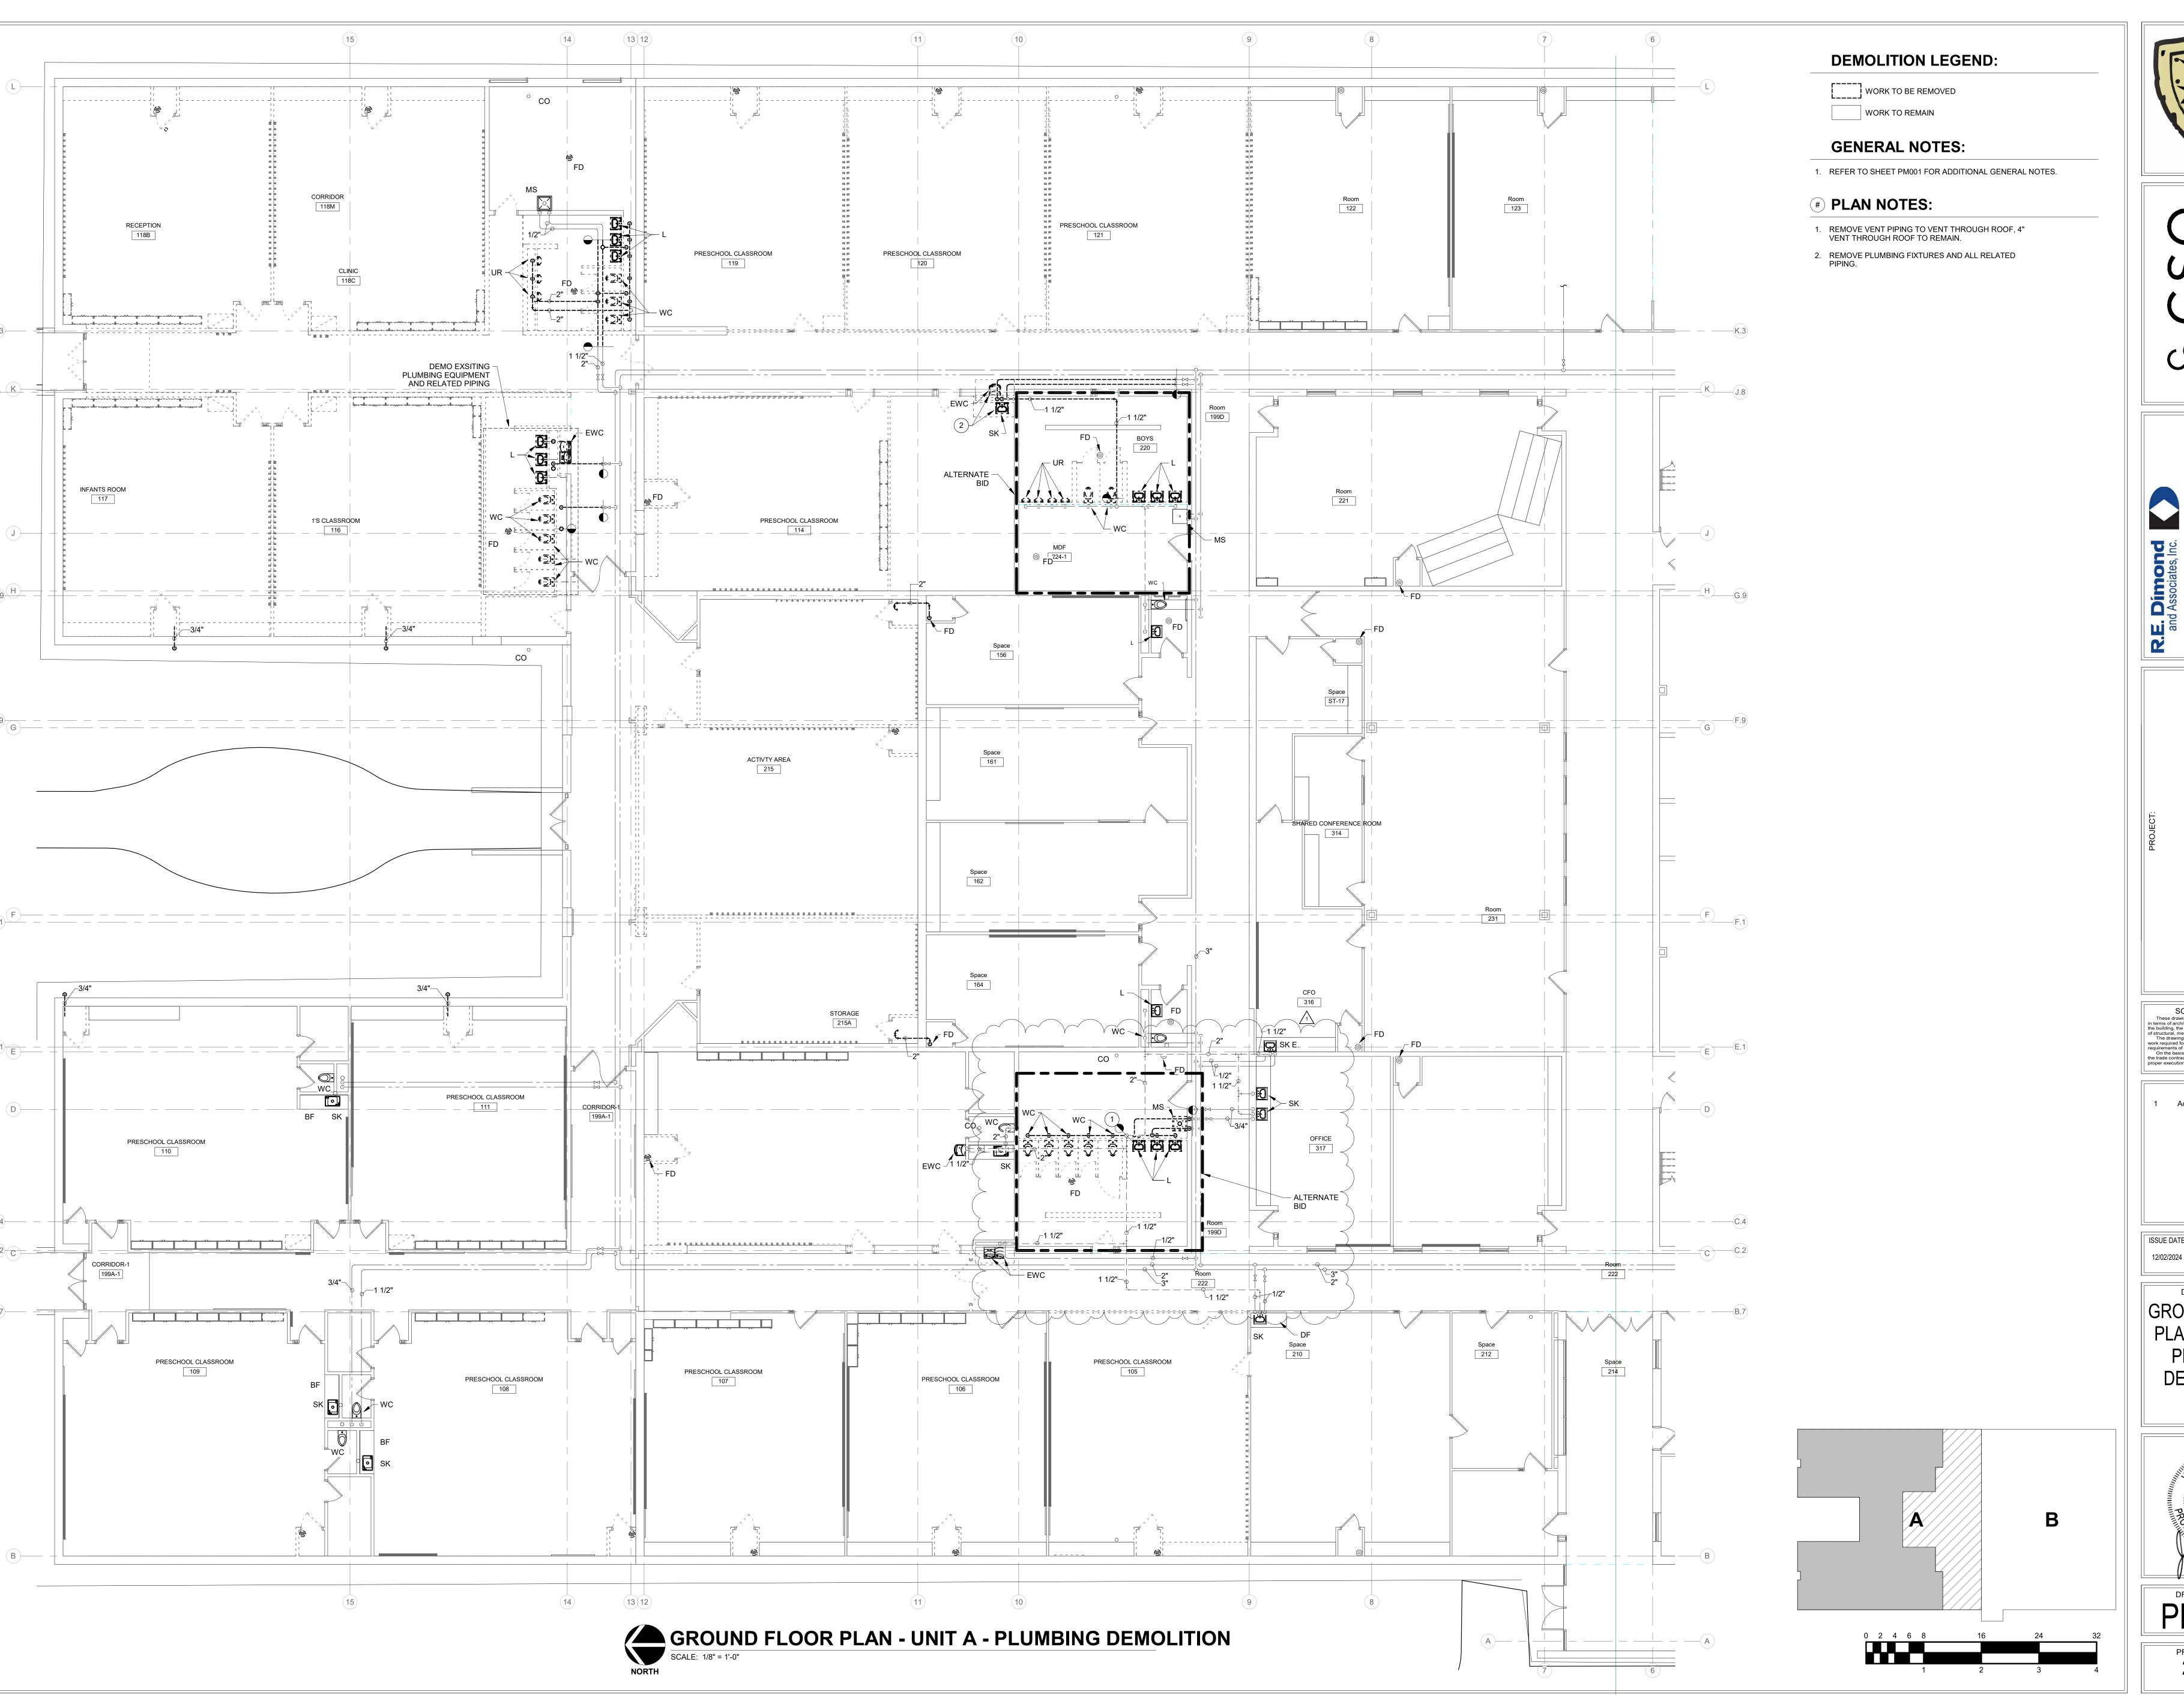
Addendum 1 01/06/2025

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DRAWING TITLE: UNDERSLAB PLAN - UNIT A -PLUMBING **DEMOLITION** 



PD101A PROJECT NUMBER 2023032





S831 Keystone Crossing, Indianapolis, IN 46240

no. of

and Associates, Inc.
Consulting Engineers


MVCSC ADMIN SERVICE CENINTERIOR RENOVATIONS
BID DOCUMENTS
1806 SR 234 FORTVILLE, IN 46040


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Addendum 1 01/06/2025

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GROUND FLOOR
PLAN - UNIT A PLUMBING
DEMOLITION






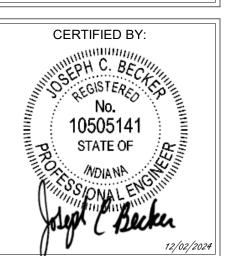


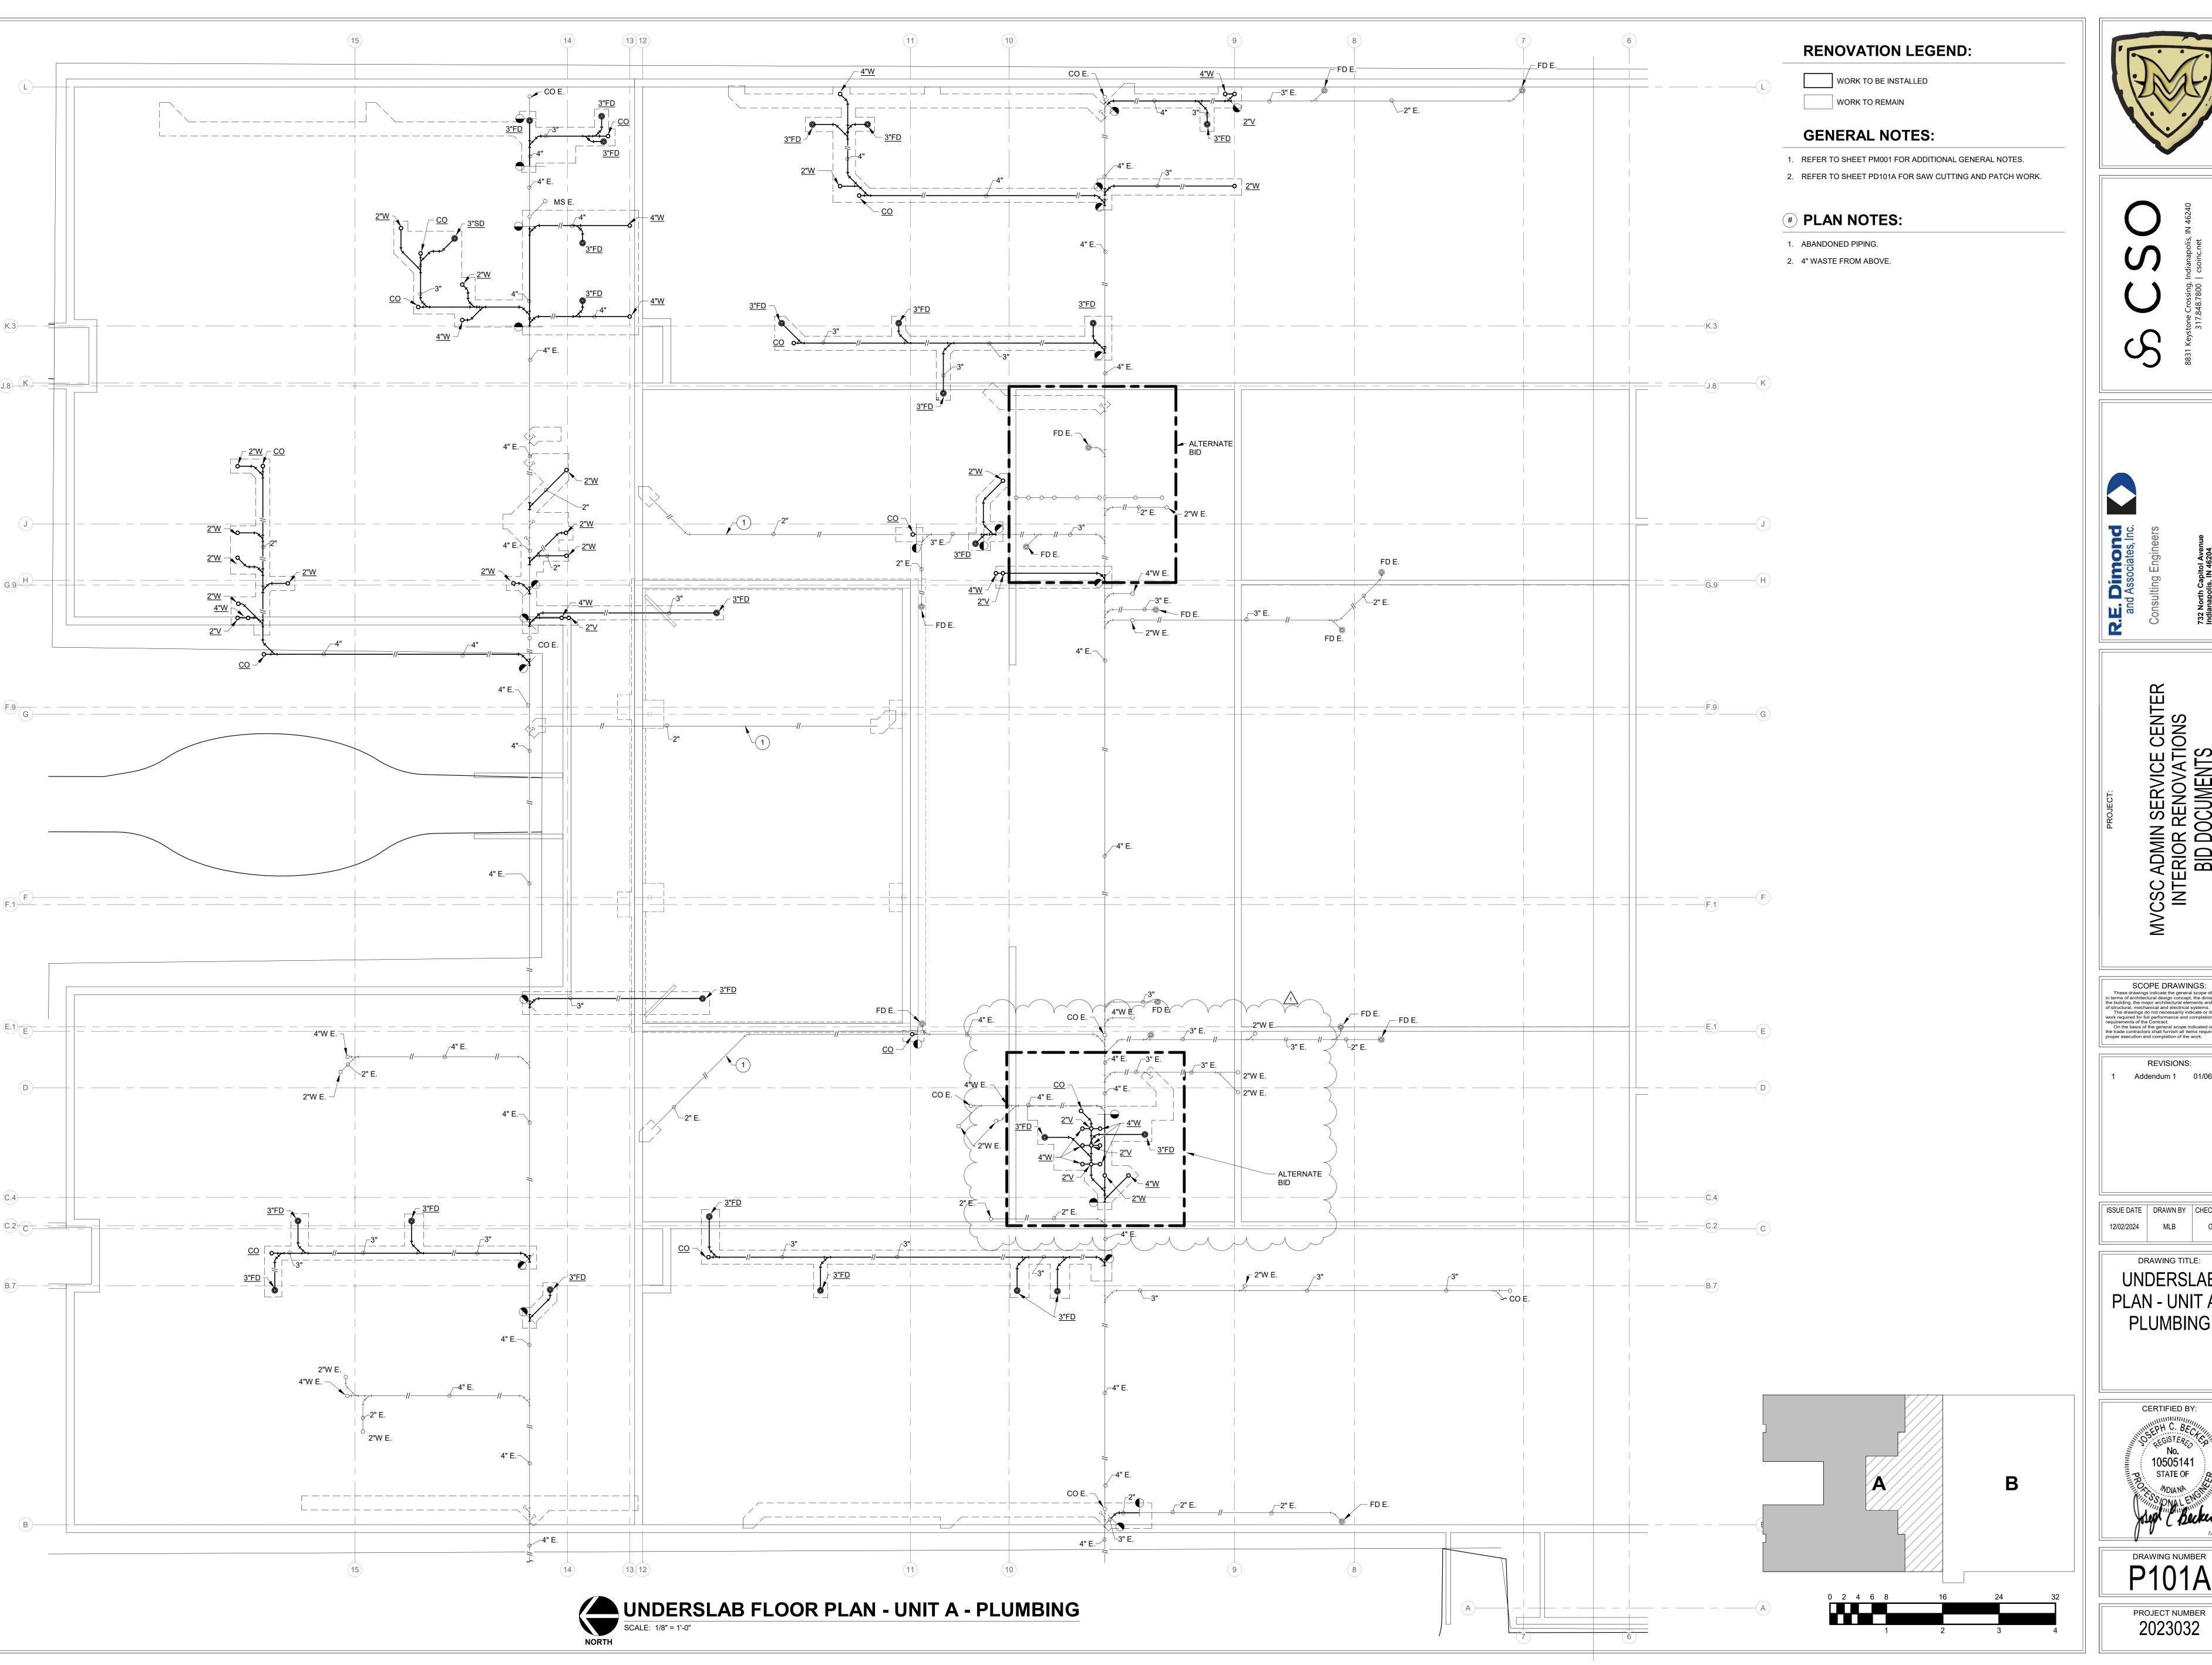Addendum 1 01/06/2025

UNDERSLAB PLAN - UNIT A -PLUMBING

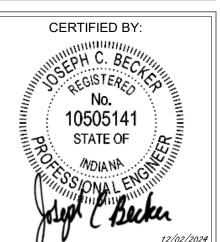

DRAWING NUMBER P101A

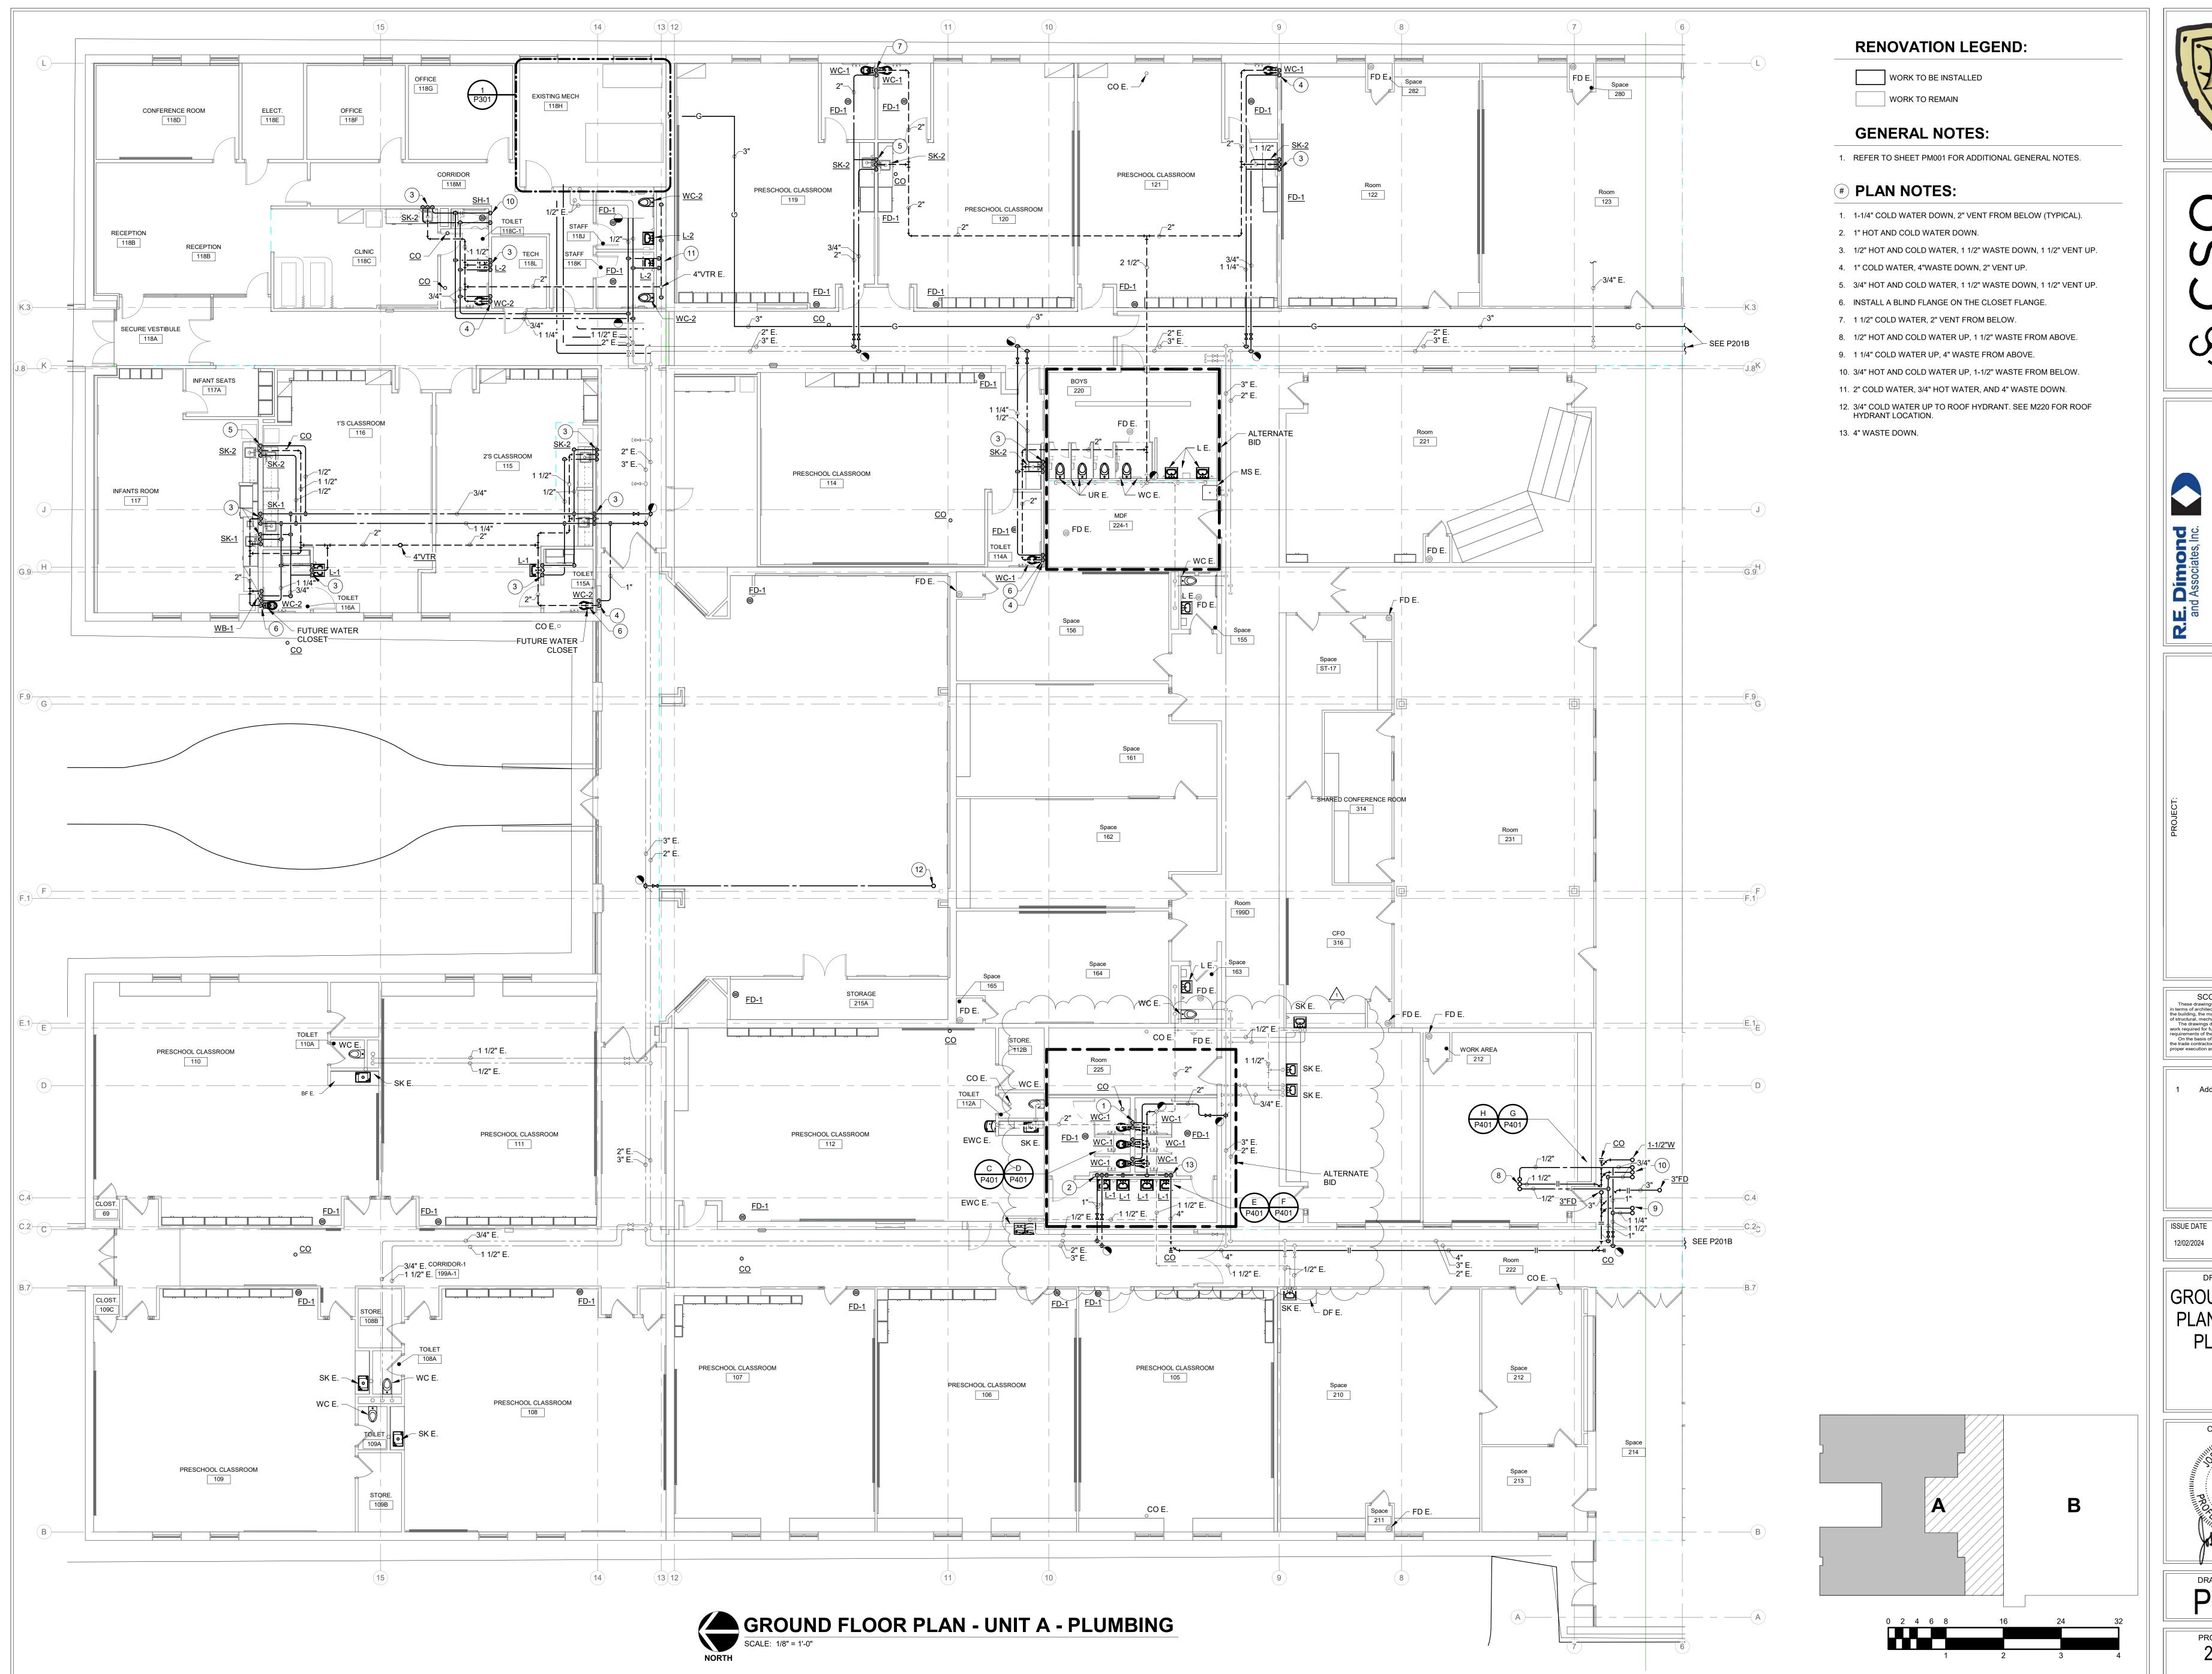



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Consulting Engineers

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INTERIOR RENOVATIONS
BID DOCUMENTS
1806 SR 234 FORTVILLE, IN 46040

SCOPE DRAWINGS:

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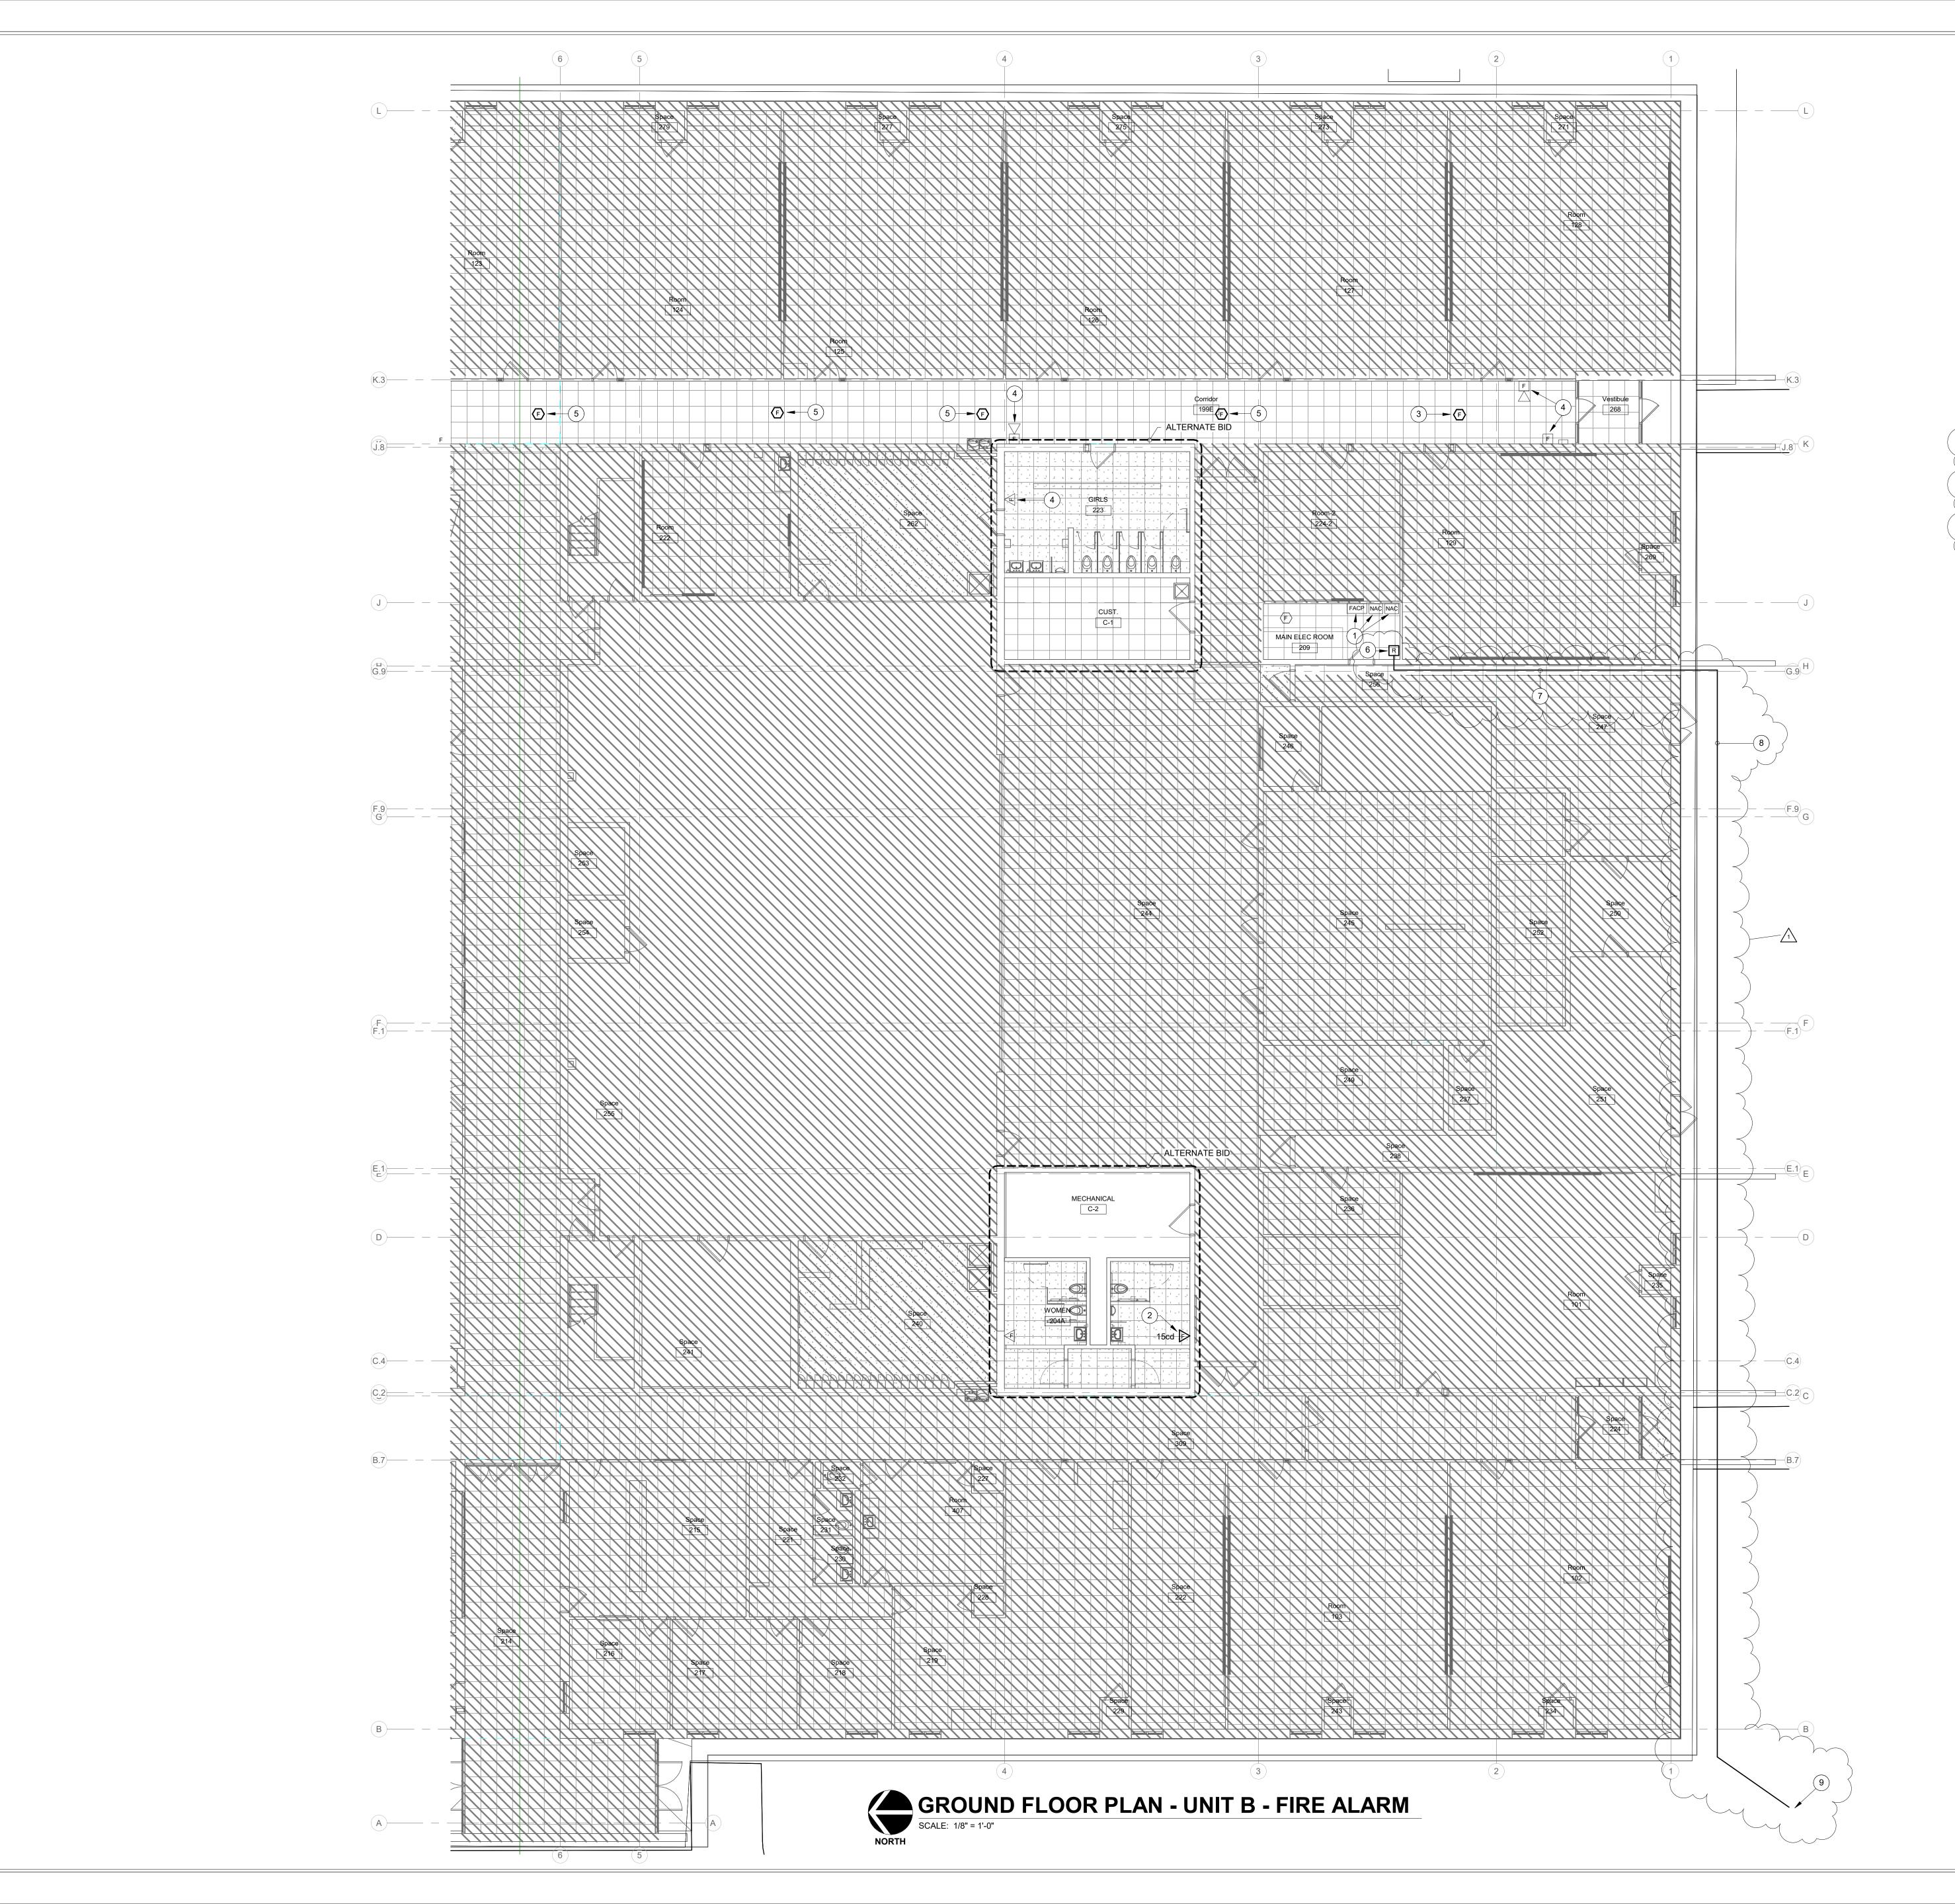
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GROUND FLOOR
PLAN - UNIT A PLUMBING





#### **RENOVATION LEGEND:**

WORK TO BE INSTALLED


WORK TO REMAIN

#### **GENERAL NOTES:**

1. REFER TO DRAWING E001 FOR ADDITIONAL GENERAL NOTES.

### **# PLAN NOTES:**


- EXISTING NOTIFIER NWF-100X FIRE ALARM CONTROL PANEL AND (2) FCPS-24 POWER SUPPLIES TO REMAIN. PROVIDE SURFACE MOUNTED STROBE LIGHT ON 4" SQ. WIREMOLD BACK BOX. STROBE LIGHT TO MATCH
- EXISTING UNIT IN WOMEN'S RESTROOM. PROVIDE NEW DEVICE. IF POSSIBLE, MANUFACTURER AND MODEL NUMBER TO MATCH EXISTING.
- 4. EXISTING TO REMAIN.
- 5. RELOCATE EXISTING DEVICE TO THIS LOCATION.
- PROVIDE ADDRESSABLE MONITOR MODULE TO MONITOR SPRINKLER SYSTEM PIV.
- 7. ROUTE 3/4" EMT TO EXTERIOR WALL. ROUTE DOWN TO PENETRATE THE WALL THEN CONVERT TO 3/4" HDPE . PROVIDE SLEEVE AND SEAL.
- 9. PROVIDE CONNECTIONS TO MONITOR PIV CONTACTS. REFER TO C400 FOR PIV LOCATION.

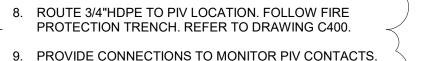



DRAWING TITLE:

GROUND FLOOR PLAN - UNIT B -FIRE ALARM

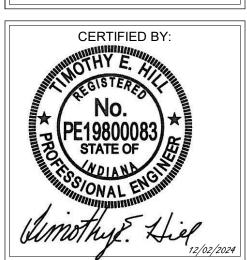

E231B